



2 EAST ELEVATION 1/8" = 1'-0"

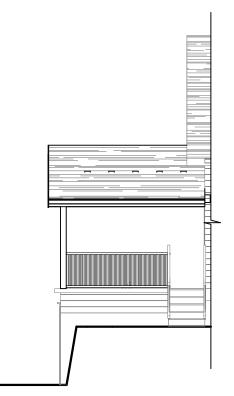


WEST ELEVATION 1/8" = 1'-0"

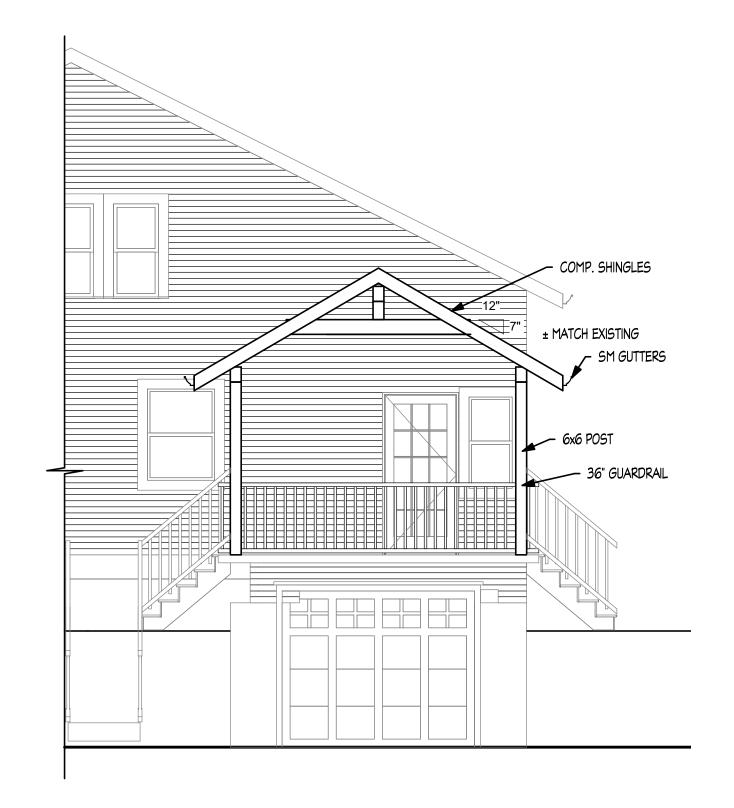

1 NORTH ELEVATION
1 1/4" = 1'-0"

BUILDERS		COMMERCIAL · RESIDENTIAL · REMODELING	11125 NE WEIDLER ST. · PORTLAND, OR 97220 PHONE: (503) 252-3453 · FAX: (503) 252-3454 EMAIL: BUILDERSDESIGN@GMAIL.COM
	ALEX BORHO	ELEVATIONS	
Project numbe	er:		10924
Date:			9/27/17
Drawn by:			KG
			BSY
Checked by:			
Checked by: Area:			 indicated

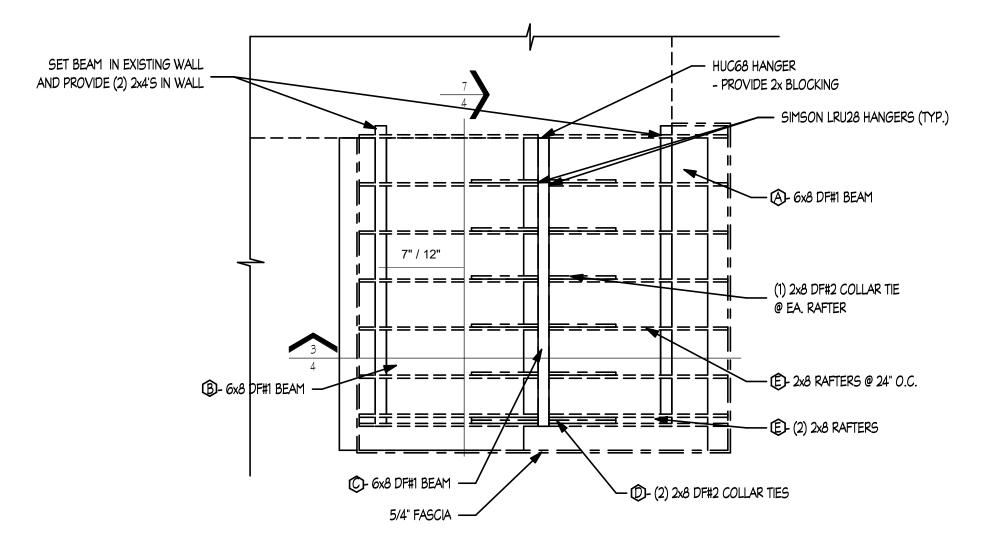

5	ROOF FRAMING PLAN
2	1/4" = 1'-0"

BULLERSDENTIAL REMODELING COMMERCIAL RESIDENTIAL REMODELING 11125 NE WEIDLER ST. PORTLAND, OR 97220 PHONE: (503) 252-3453 · FAX: (503) 252-3454 EMAIL: BUILDERSDESIGN@GMAIL.COM

ALEX BORHO ROOF PLAN

 Project number:
 10924

 Date:
 9/27/17


 Drawn by:
 KG


 Checked by:
 BSY

 Area:
 -

 Scale:
 1/4" = 1'-0"


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ALEX BORHO BASEMENT AND 1 FLOOR PLANS

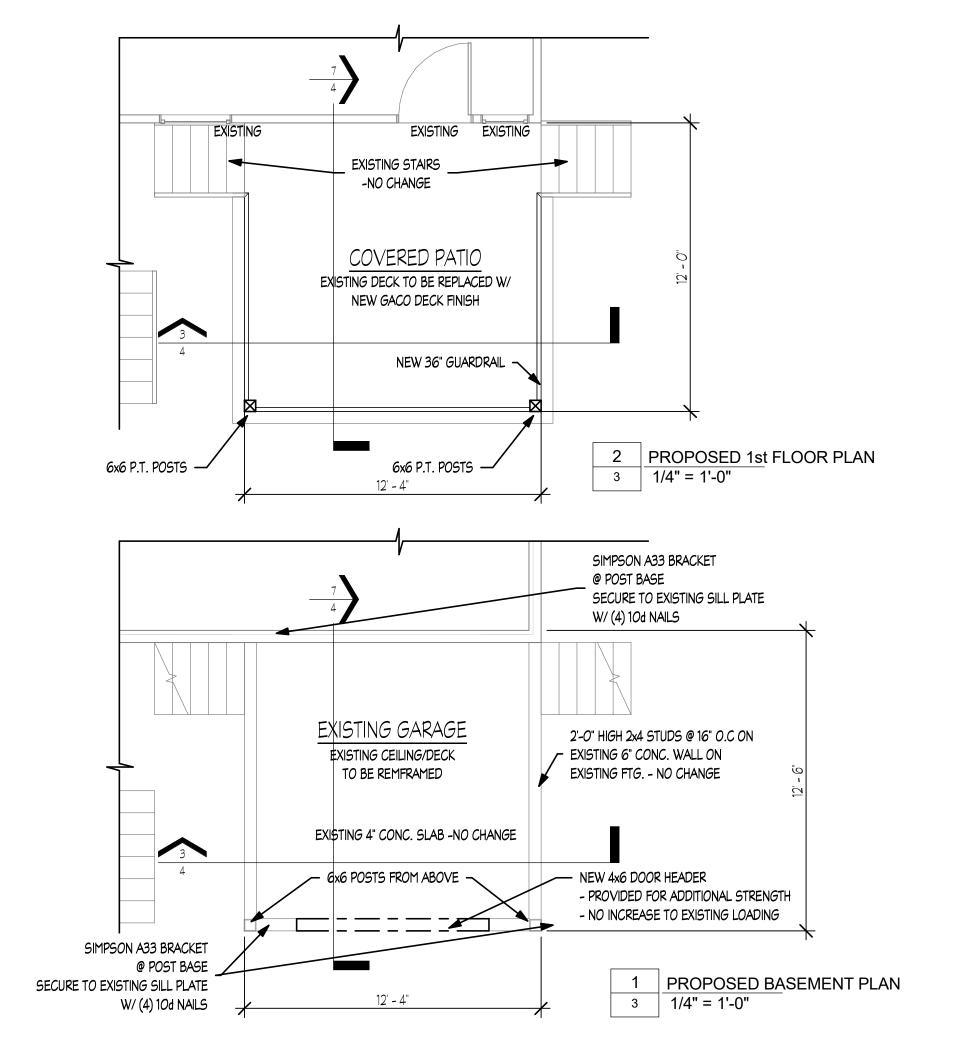Project number:	10924
Date:	9/27/17
Drawn by:	KG
Checked by:	BSY
Area:	
Scale:	1/4" = 1'-0"
	3

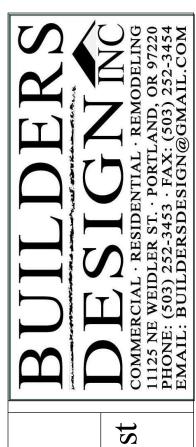



ALEX BORHO
SECTIONS

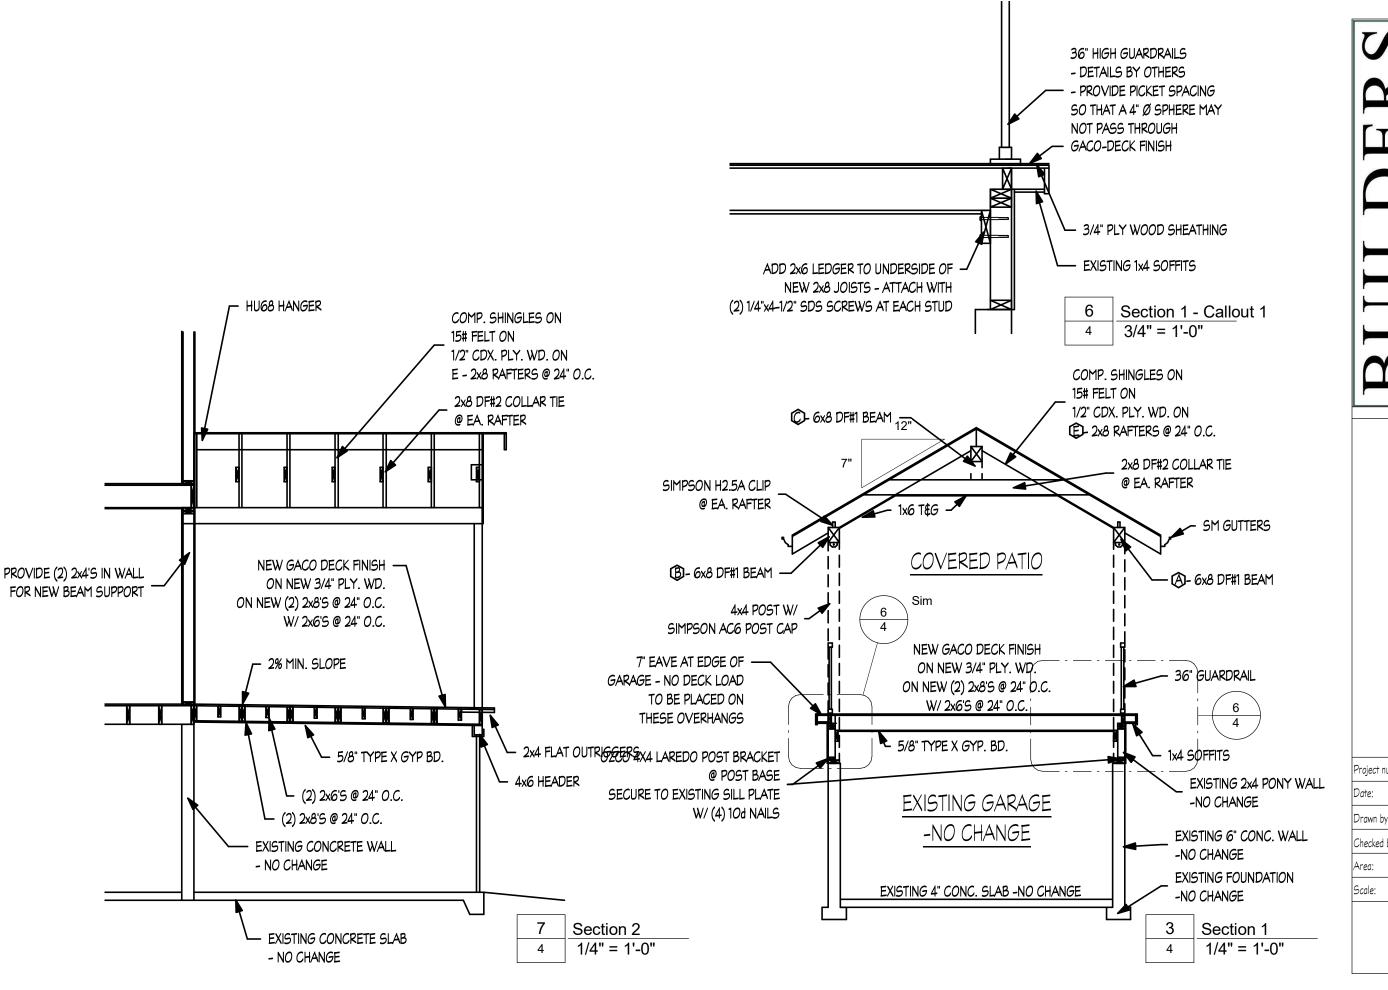Project number:	10924
Date:	9/27/17
Drawn by:	KE
Checked by:	BSY
Area:	
Scale:	As indicated

4

- 1. ALL WORK SHALL CONFORM WITH THE LATEST ADOPTED ISSUE OF THE OREGON 2014 RESIDENTIAL SPECIALTY CODE.
- 2. THE CONTRACTOR IS RESPONSIBLE FOR CHECKING THE PLANS AND SITE CONDITIONS AND TO NOTIFY THE ARCHITECT OF ANY ERRORS OR OMISSIONS PRIOR TO THE START OF CONSTRUCTION.
- 3. WRITTEN DIMENSIONS HAVE PRECEDENCE OVER SCALED DIMENSIONS

- 1. REMOVE TOP SOIL AND ORGANIC MATERIAL FROM THE BUILDING SITE, STOCKPILING ON SITE FOR FINAL GRADING IF POSSIBLE. 2. FOOTINGS ARE TO BEAR ON UNDISTURBED LEVEL SOIL, STEPPED AS REQUIRED TO MAINTAIN THE REQUIRED DEPTH BELOW FINISH
- 3. ANY FILL UNDER GRADE SUPPORTED CONCRETE SLABS TO BE 4" THICK (MIN.) SAND COMPACTED TO 95%.
- 4. CONCRETE SLABS TO BE 4" THICK, 3000 P.S.I AT 28 DAYS WITH CONTROL JOINTS AT 25 O/C (MAX.) EACH WAY
- 5. FINISH GRADES ARE TO REMAIN AT LEAST 6" BELOW FINISH SIDING.

1. CONCRETE - MIX AND 28 DAY STRENGTH OF CONCRETE

- BASEMENT WALLS & FOUNDATION NOT EXPOSED TO WEATHER

2500 PSI - BASEMENT & INTERIOR 2500 PSI

SLABS ON GRADE:

- BASEMENT WALLS & FOUNDATIONS EXPOSED TO WEATHER

AND GARAGE SLABS: 3000 PSI

-PORCHES, STEPS & CARPORT

SLABS EXPOSED TO WEATHER: 2. ALL REINFORCING STEEL TO BE A-615 GRADE 60. WELDED WIRE MESH TO BE A-185.

3. LAP ALL CONTINUOUS BARS 30 x DIA. (MIN.) PLACE ALL REINFORCING AS PER A.C.I. CODES & STANDARDS.

4. PROVIDE A MINIMUM CLEARANCE OF 18" UNDER GIRDERS, BEAMS, OR JOISTS.

FLASHING & MOISTURE PROTECTION

- I. CONTRACTOR TO PROVIDE A "WATER TIGHT ENCLOSURE" FOR THE VALLEY ENVIRONMENT, EMPLOYING THE HIGHEST QUALITY MATERIALS, CRAFTSMAN AND CONSTRUCTION METHODOLOGY, BOTH GENERAL AND SPECIFIC TO THE VALLEY
- 2. ALL EXTERIOR FLASHING ARE TO BE CONSTRUCTED WITH MIN. GAGE 28 EXPOSED \$ 30 GAGE CONCEALED, BAKED ENAMEL
- 3. FLASHING SHALL BE INSTALLED AT JUNCTIONS OF CHIMNEYS AND ROOFS, IN ROOF VALLEYS AND AROUND ALL ROOF OPENINGS, INCLUDING SKYLIGHTS, ROOF VENTS, ROOF EDGES BOTH RAKE AND EAVE.
- 4. FLASHING SHALL BE INSTALLED AROUND ALL EXTERIOR DOORS AND WINDOWS, TRANSITIONS BETWEEN SIDING AND ROOF.
- 5. ALL FLASHING TO BE INSTALLED PER "SMACNA" LATEST EDITION OF THE "ARCHITECTURAL SHEET METAL MANUAL".
- 6. BUILDING WRAP OF "TYVEK" OR SAME TO BE INSTALLED PER MANUFACTURERS INSTRUCTIONS, INCLUDING WRAPPING WINDOW AND DOOR OPENINGS AND TAPING JOINTS.

ROOF VENTILATION

R806.1 VENTILATION REQUIRED.

ENCLOSED ATTICS AND ENCLOSED RAFTER SPACES FORMED WHERE CEILINGS ARE APPLIED DIRECTLY TO THE UNDERSIDE OF ROOF RAFTERS SHALL HAVE CROSS VENTILATION FOR EACH SEPERATE SPACE BY VENTILATING OPENINGS PROTECTED AGAINST THE ENTRANCE OF RAIN OR SNOW. VENTILATION OPENINGS SHALL HAVE AT LEAST DIMENSION OF 1/16" MINIMUM AND 1/4" MAXIMUM. VENTILATION OPENINGS HAVING AT LEAST DIMENSION LARGER THAN 1/4" SHALL BE PROVIDED WITH CORROSION-RESISTANT WIRE CLOTH SCREENING, HARDWARE CLOTH, OR SIMILAR MATERIAL, OPENINGS IN ROOF FRAMING MEMBERS SHALL CONFORM WITH THE REQUIREMENTS OF SECTION R802.7

THE TOTAL NET FREE VENTILATING AREA SHALL NOT BE LESS THAN 1/150 OF THE AREA OF THE SPACE VENTILATED EXCEPT THAT REDUCTION OF THE TOTAL AREA TO 1/300 IS PERMITTED PROVIDED THAT AT LEAST 50% AND NOT MORE THAN 80% OF THE REQUIRED VENTILATING AREA IS PROVIDED WITH VENT OPENINGS LOCATED IN THE UPPER PORTION OF HTE SPACE TO BE VENTILATED AT LEAST 3' ABOVE THE FAVE OR CORNICE VENTS WITH THE BALANCE OF THE REQUIRED VENTIL ATION PROVIDED BY FAVE OR CORNICE VENTS AS AND ALTERNATIVE, THE NET FREE CORSS-VENTILATION AREA MAY BE REDUCED TO 1/300 WHEN A VAPOR RETARDER HAVING A TRANSMISSION RATE NOT EXCEEDING 1 PERM IS INSTALLED ON THE WARM IN WINTER SIDE OF THE CEILING.

R806.3 VENT AND INSULATION CLEARANCE.

WHERE EAVE OR CORNICE VENTS ARE INSTALLED, INSULATION SHALL NOT BLOCK THE FREE FLOW OF AIR, A MINIMUM OF 1 INCH SPACE SHALL BE PROVIDED BETWEEN THE INSULATION AND THE ROOF SHEATHING AND AT THE LOCATION OF THE VENT.

- FOR ROOF SLOPES FROM 2 UNITS VERTICAL IN 12 UNITS HORIZONTAL UP TO 4 UNITS VERTICAL IN 12 UNITS HORIZONTAL, UNDERLAYMENT SHALL BE TWO LAYERS APPLIED IN THE FOLLOWING MANNER: APPLY A 19 INCH STRIP OF UNDERLAYMENT FELT PARALLEL TO AND STARTING AT THE EAVES, FASTENED SUFFICIENTLY TO HOLD IN PLACE. STARTING AT THE EAVE, APPLY 36 INCH WIDE SHEETS OF UNDERLAYMENT, OVERLAPPING SUCCESSIVE SHEETS 19 INCHES, AND FASTENED SUFFICIENTLY TO HOLD IN PLACE. DISTORTIONS IN THE UNDERLAYMENT SHALL NOT INTERFERE WITH THE ABILITY OF THE SHINGLES TO SEAL. -FOR ROOF SLOPES OF 4 UNITS IN 12 OR GREATER, UNDERLAYMENT SHALL BE ONE LAYER APPLIED IN THE FOLLOWING MANNER: UNDERLAYMENT SHALL BE APPLIED SHINGLE FASHION, PARALLEL TO AND STARTING FROM THE EAVE AND LAPPED 2 INCHES, FASTENED SUFFICIENTLY TO HOLD IN PLACE. DISTORTIONS IN THE UNDERLAYMENT SHALL NOT INTERFERE WITH THE ABILITY OF THE SHINGLES TO SEAL, END LAPS SHALL BE OFFSET BY 6'.

NAILING SCHEDULE: JOIST TO SILL OF GIRDER: TOE NAIL BRIDGE TO JOIST TOE NAIL BOTTOM PLATE TO JOIST 16d@16" O.C. FACE NAIL PLYWOOD SUBFLOOR 8406 FDGF NAII 8d @ 12" INTERIOR TOP PLATE TO JOIST END NAIL STUD TO BOTTOM PLATE TOE OR END NAIL 16d@ 16" O.C. DOUBLE STUDS FACE NAIL DOUBLE TOP PLATE 16d@ 16" O.C. FACE NAIL CONTINUOUS HEADER (2 PC) 16d@ 16" O.C. EDGE NAIL CEILING JOIST TO PLATE FACE NAIL CEILING JOIST LAP OVER PLATE (3) 16d FACE NAIL CEILING JOIST TO RAFTER FACE NAIL (3) 16dRAFTER TO TOP PLATE TOE NAIL COLLAR TIES (EACH END) (6) 10d (U.N.O.) FACE NAIL BUILD UP CORNER STUDS 16d @ 24" O.C. FACE NAIL TOP PLATE AT INTERSECTIONS FACE NAIL MULTIPLE LVL'S (2 PLIES) 2 ROWS - 16d @ 12" O.C. STAGGERED 2 ROWS - 16d @ 12" O.C. STAGGERED MULTIPLE LVL'S (3 PLIES) MULTIPLE JOISTS (UP TO 3) 2 ROWS - 16d @ 12" O.C. STAGGERED 1x6 SPACED SHEATHING FACE NAIL

FOUNDATIONS

RAFTERS TO HIPS, VALLEY OR RIDGE

1. WOOD FRAMING MEMBER GRADES ARE AS FOLLOWS UNLESS, OTHERWISE NOTED ON THE DRAWINGS: A. POSTS, BEAMS, HEADERS, JOISTS AND RAFTERS - NO. 1 DOUG FIR OR LVL'S - 2650 FB \$1.8E B. PLATES, BLOCKING AND BRIDGING -NO. 3 DOUG FIR C. STUDS -STUD GRADE DOUG FIR D. T&G DECKING STUD & BETTER GRADE DOUG FIR E. PLY. SHEATHING -CD DOUG FIR PLY. (32/16)

F GLU-LAM -24-F V-4 2. UNLESS OTHERWISE NOTED ON DRAWINGS, ALL EXTERIOR WINDOW AND DOOR HEADERS ARE TO BE 4x12 DOUG FIR No. 1


3. DESIGN LOADS:

25 P.S.F. (LL) 40 P.S.F. (LL) FLOOR -STAIRS -100 P.S.F. (LL) GARAGE FLOOR -50 P.S.F. (LL) DECKS -40 P.S.F. (LL)

4. SOIL BEARING PRESSURE IS ASSUMED TO BE 1500 P.S.F.


- 5. NAILING SCHEDULE AS PER TABLE 25-Q, U.B.C., TYPICAL PLYWOOD NAILING WITH 8d NAILS @ 6" O/C AT EDGES AND 12" O.C. FIELD.
- 6. DECK AND BALCONY GUARDRAILS TO BE 36" HIGH WITH MAXIMUM OPENING SPACES SO THAT A 4" SPHERE CAN NOT PASS THROUGH.
- 7. PROVIDE METAL TRUSS AND RAFTER TIE DOWNS SUCH AS A, "SIMPSON" H2.5A TO EACH RAFTER AT TOP PLATE.
- 8. ALL EXTERIOR FASTENERS, EXPOSED TO THE ELEMENTS TO BE STAINLESS STEEL OR GALVANIZED. INCLUDING NAIL, STAPLES, CLIPS, ETC.

ASPHALT SHINGLES SHALL BE USED ONLY ON ROOF SLOPES OR 2/12 OR GREATER. FOR ROOF SLOPES FROM 2/12 TO 4/12, DOUBLE UNDERLAYMENT APPLICATION IS REQUIRED.

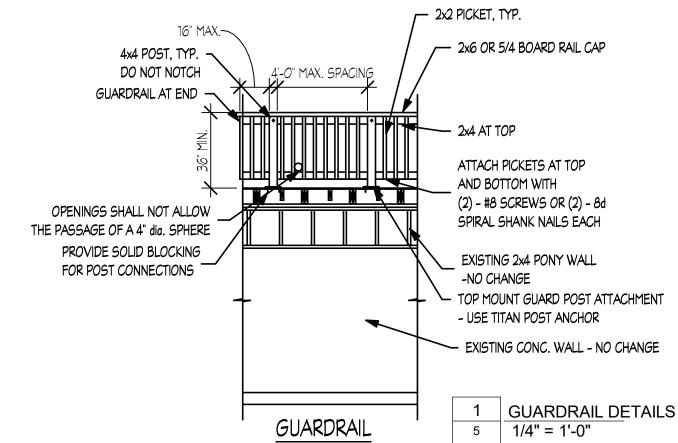

口 BORHO Ш EX GENER

oject number:	10924
ate:	9/27/17
rawn by:	KG
necked by:	BSY
rea:	09/27/17
cale:	1/4" = 1'-0"

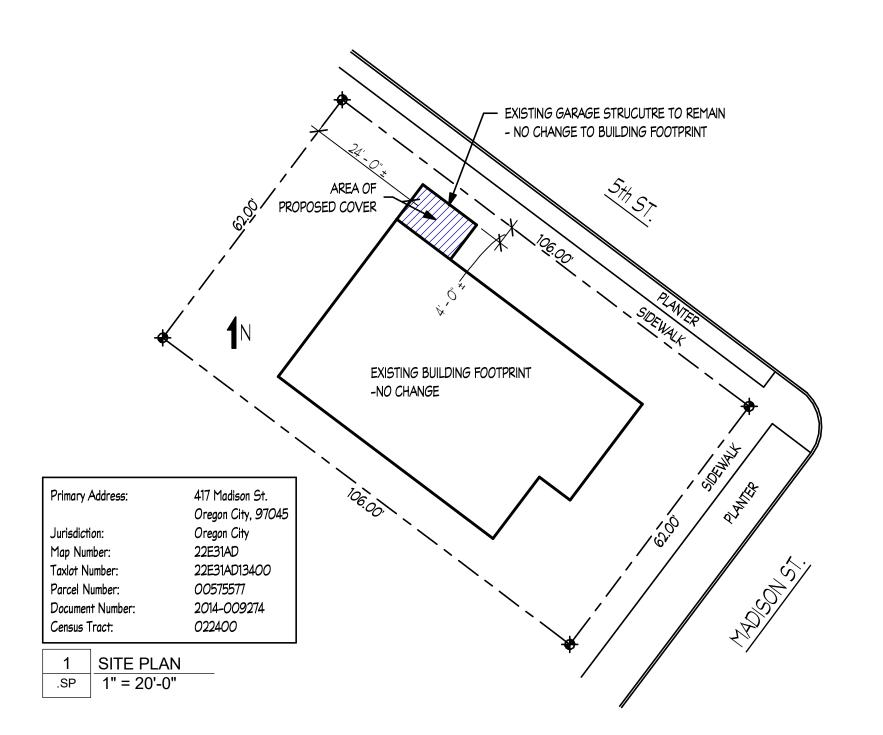

BUILDERSDESIGN@GMAIL.COM

ALEX BORHO
SITE PLAN

 Project number:
 10924

 Date:
 9/27/17

 Drawn by:
 KG

 Checked by:
 BSY

Area: 09/27/17 Scale: 1" = 20'-0"

.SP