
OREGON CITY PUBLIC LIBRARY RENOVATION & ADDITION SITE PLAN DESIGN REVIEW & HISTORIC DESIGN REVIEW SUBMITTAL

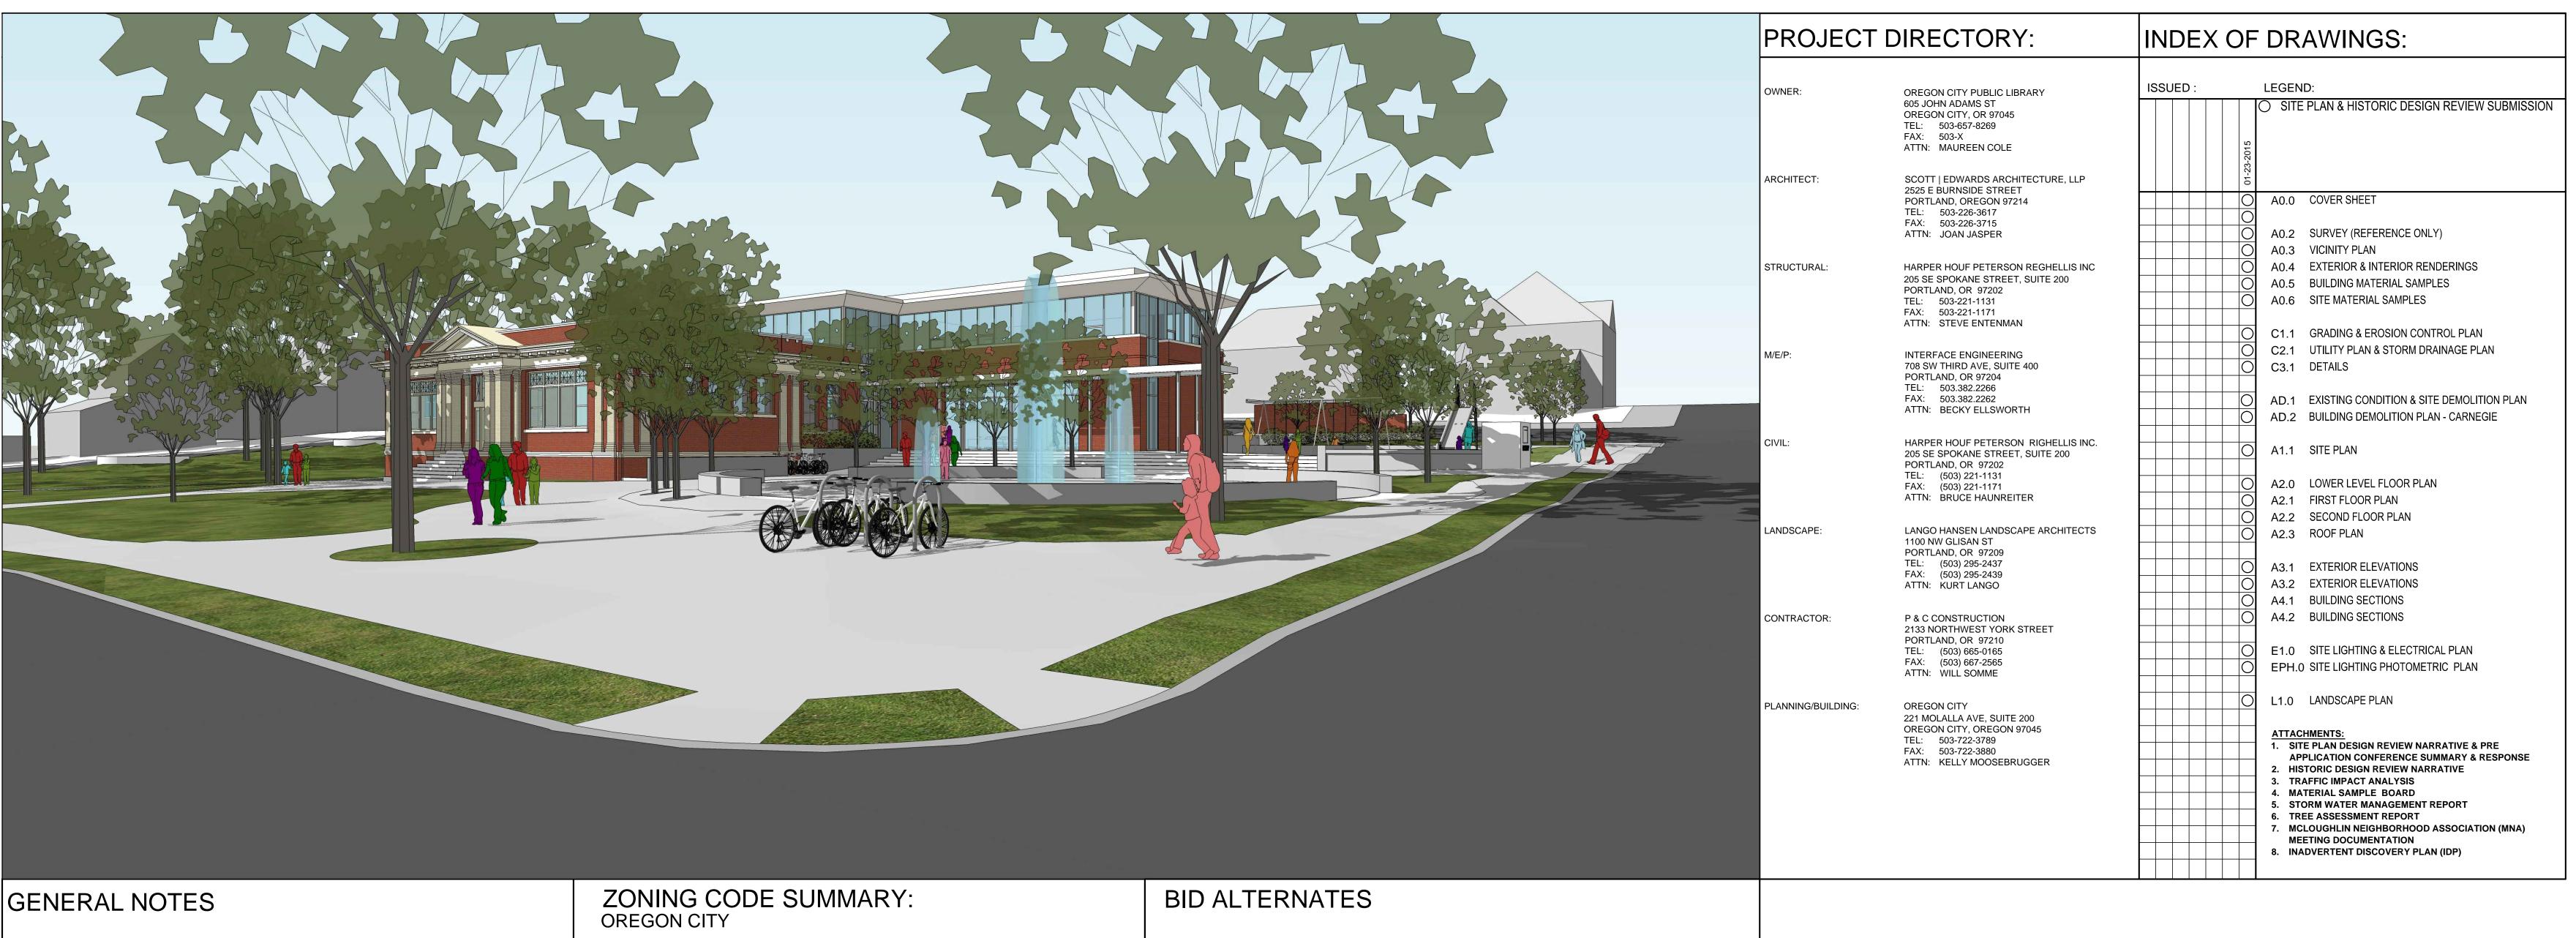



OREGON CITY **PUBLIC LIBRARY RENOVATION & ADDITION**

OREGON CITY, OREGON

THE CONTRACTOR SHALL FIELD VERIFY ALL CONDITIONS AND DIMENSIONS PRIOR TO ANY WORK AND SHALL BE RESPONSIBLE FOR ALL WORK AND MATERIALS INCLUDING THOSE FURNISHED BY SUBCONTRACTORS.

DIMENSIONS TAKE PRECEDENCE OVER DRAWING: DO NOT SCALE DRAWINGS TO DETERMINE ANY LOCATIONS. THE ARCHITECT SHALL BE NOTIFIED OF ANY DISCREPANCY PRIOR TO CONTINUING WITH

ALL DIMENSIONS ON PLANS ARE FROM FACE OF STUD UNLESS NOTED OTHERWISE

ALL CONSTRUCTION SHALL COMPLY WITH THE 2014 OREGON STRUCTURAL SPECAILTY CODE, AND ALL LOCAL GOVERNING BUILDING CODES AND ORDINANCES.

THE CONTRACTOR SHALL REPORT TO THE ARCHITECT ANY ERRORS, INCONSISTENCIES OR OMISSIONS HE OR SHE MAY DISCOVER. THE CONTRACTOR IS RESPONSIBLE FOR CORRECTING ANY ERROR AFTER THE START OF CONSTRUCTION WHICH HAS NOT BEEN BROUGHT TO THE ATTENTION OF THE ARCHITECT. THE MEANS OF CORRECTING ANY ERROR SHALL FIRST BE APPROVED BY THE ARCHITECT.

ALL REQUIRED CITY AND/OR COUNTY LICENSE SHALL BE ACQUIRED AND PAID FOR BY THE INDIVIDUAL

THE ARCHITECT WILL REVIEW SHOP DRAWINGS AND SAMPLES FOR CONFORMANCE WITH THE DESIGN CONCEPT OF THE PROJECT. THE ARCHITECT'S REVIEW OF A SEPARATE ITEM SHALL NOT INDICATE APPROVAL OF AN ASSEMBLY IN WHICH THE ITEM FUNCTIONS.

IT SHALL BE THE RESPONSIBILITY OF THE CONTRACTOR TO VERIFY LOCATION OF ALL EXISTING UTILITIES WHETHER SHOWN HEREIN OR NOT AND TO PROTECT THEM FROM DAMAGE. THE CONTRACTOR SHALL BEAR ALL EXPENSES OF REPAIR OR REPLACEMENT OF UTILITIES OR OTHER PROPERTY DAMAGED BY OPERATIONS IN CONJUNCTION WITH THE EXECUTION OF THE WORK.

CITY APPROVED PLANS SHALL BE KEPT IN A SECURE PLACE AND SHALL NOT BE USED BY WORKERS. THE CONTRACTOR SHALL BE RESPONSIBLE THAT ALL SUBCONTRACTORS' CONSTRUCTION SETS REFLECT THE SAME INFORMATION. THE CONTRACTOR SHALL ALSO MAINTAIN, IN GOOD CONDITION, ONE COMPLETE SET OF STAMPED CITY APPROVED PLANS WITH ALL REVISIONS, ADDENDUMS, AND CHANGE ORDERS, ON THE PREMISES AT ALL TIMES. THESE ARE TO BE UNDER THE CARE OF THE JOB SUPERINTENDENT AND MUST BE MADE AVAILABLE TO BUILDING AND FIRE INSPECTORS FOR REFERENCE DURING CONSTRUCTION.

THE CONTRACTOR SHALL BE RESPONSIBLE FOR THE COMPLETE SECURITY OF THE SITE WHILE THE JOB IS IN PROGRESS AND UNTIL JOB COMPLETION.

ALL DEBRIS SHALL BE REMOVED FROM THE PREMISES AND ALL AREAS SHALL BE LEFT IN A BROOM CLEAN CONDITION AT ALL TIMES.

THE CONTRACTOR SHALL TAKE ALL NECESSARY PRECAUTIONS TO ENSURE THE SAFETY OF THE OCCUPANTS AND WORKERS AT ALL TIMES.

. THE CONTRACTOR IS SOLELY RESPONSIBLE FOR ALL CONSTRUCTION MEANS AND METHODS AND SHALL MAINTAIN THE STRUCTURAL INTEGRITY AND FIRE RATING OF ANY CONSTRUCTION UNTIL ALL FINAL LATERAL AND VERTICAL LOAD CARRYING SYSTEMS ARE COMPLETED.

THE CONTRACTOR SHALL BE RESPONSIBLE FOR AND SHALL REPLACE OR REMEDY ANY FAULTY, IMPROPER OR INFERIOR MATERIALS OR WORKMANSHIP WHICH SHALL APPEAR, WITHIN ONE (1) YEAR AFTER THE COMPLETION AND ACCEPTANCE OF THE WORK UNDER THIS CONTRACT.

ALL ELECTRICAL, MECHANICAL AND PLUMBING WORK SHALL CONFORM TO THE REQUIREMENTS OF THE CURRENT NEC, OMSC, UPC RESPECTIVELY

CONTRACTOR TO PROVIDE BACKING OR BLOCKING AS REQUIRED FOR MOUNTING ALL WALL MOUNTED SHELVES, EQUIPMENT, ACCESSORIES, CABINETS, ETC.

. CONTRACTOR TO PROTECT ALL TREES AND ROOTS NOT SLATED FOR REMOVAL DURING CONSTRUCTION

GENERAL CONTRACTOR RESPONSIBLE FOR MAINTENANCE OF STAGING AREA, AND TO ENSURE THAT MATERIALS DELIVERY AND STORAGE DOES NOT INTERFERE WITH DAILY OPERATION OF ADJACENT

PLANNING DESIGNATION:

INSTITUTIONAL DISTRICT COMPREHENSIVE PLAN: PARKS (MCD) HISTORIC DISTRICT: ADJACENT ZONING:

MC LOUGHLIN CONSERVATION DISTRICT (MUC-1) MIXED USE CORRIDOR DISTRICT (MODERATE DENSITY) PERMITTED USE OUTRIGHT: LIBRARY

SITE DATA: SITE AREA TAX LOT

SETBACKS:

MAX BLDG HT:

LANDSCAPE REQ:

FRONT:

57,499 SF 1.3 ACRES 2-2E-31 AD-1099 ADDRESS 606 JOHN ADAMS ST, OREGON CITY OR 97045 SITE DESIGN REVIEW:

TYPE II W/ TYPE III (PUBLIC HEARING) W/ HISTORIC DESIGN REVIEW (I), (MUC-1), (HC) 0' MIN - 5' MAX IF ADJACENT TO PUBLIC RIGHT OF WAY. (NOTE: PUBLIC RIGHT OF WAY ON ALL 4 SIDES OF PROPERTY)

SIDE: NOT STIPULATED. REAR: NOT STIPULATED

> 70' ALLOWED (35' IF WITHIN 100' FT OF ANY DISTRICT BOUNDARY) (MUC-1) 40' 35' OR 3 STORIES WHICHEVER IS LESS (HC)

> > NOT STIPULATED IN I ZONING

SITE COVERAGE: (MUC-1) (HC)

NOT STIPULATED (MUC-1) 20% MIN INCLD PARKING LOT

(HC) 20% MIN INCLD PARKING LOT PARKING SUMMARY:

REQUIRED PARKING: LIBRARY PARKING (# PER UNIT NOT STIPULATED): ASSUME 2.67 SPACES PER 1000 NET LEASEABLE S.F. AS PER TRAFFIC IMPACT ANALYSIS & PARKING STUDY- DRAFT DATED DEC 2014 EXISTING BUILDING 4.62K X 3 = NEW ADDITION 13.0K X 3 = REQUIRED

LESS 25% (UP TO 25%) 13 TO BE CONFIRMED WITH CITY/PLANNING AS PER ZONING 17.52.C.1.,2.,3. TOTAL PARKING REQ (1 PER 5 SPACES NO MORE THAN 50' - SEE EXCPT) EXIST'G ADJACENT OFF SITE PARKING **JEFFERSON** 6th STREET JOHN ADAMS

8 (10) 4 ADA, 4 10 MIN, 2 REG SUBTOTAL EXIST'G OFF SITE PARKING LOT 8 SIGNED SPACES AT PUBLIC LOT TOTAL PARKING PROVIDED 42 (53)
(NOT INCLD: SHARED PUBLIC LOTS @ LIBRARY CITY PARK & ATKINSON CHURCH) TOTAL PARKING PROVIDED

BICYCLE PARKING PROVIDED COVERED NON COVERED

AREAS ARE ALSO PROHIBITED.

@ JEFFERSON

@ FIRE HOUSE

LOADING REQUIREMENTS: ZONING 17.52.090 OFF STREET LOADING REQUIRED: NOT REQUIRED 2. WHERE PARKING AREAS ARE PROHIBITED BETWEEN BUILDING AND THE STREET, LOADING IN ADDITION TO THE BASE BUILDING BID, THE CONTRACTOR SHALL PROVIDE THE FOLLOWING ALTERNATES:

. REMOVE AND RE-BUILD EXISTING INTERIOR STAIR TO BASEMENT OF CARNEGIE.

SEE ARCHITECTURAL DRAWINGS FOR ADDITIONAL SCOPE OF ALTERNATES.

2. GREENROOFS AT ENTRY CANOPIES OF LIBRARY ADDITION. 3. SKYLIGHT OVER LIBRARY ADDITION ATRIUM.

4. FULL SEISMIC UPGRADE TO EXISTING CARNEGIE

. RAISED FLOORING SYSTEM 6. SPRAY PARK CONCRETE SEAT WALL

> SITE PLAN DESIGN REVIEW & HISTORIC DESIGN REVIEW SUBMITTAL PACKAGE

Drawing: **COVER SHEET**

Job No: JANUARY 23, 2015 Drawn By: Checked By: Sheet No:




OREGON CITY


PUBLIC LIBRARY


RENOVATION &

ADDITION

OREGON CITY, OREGON

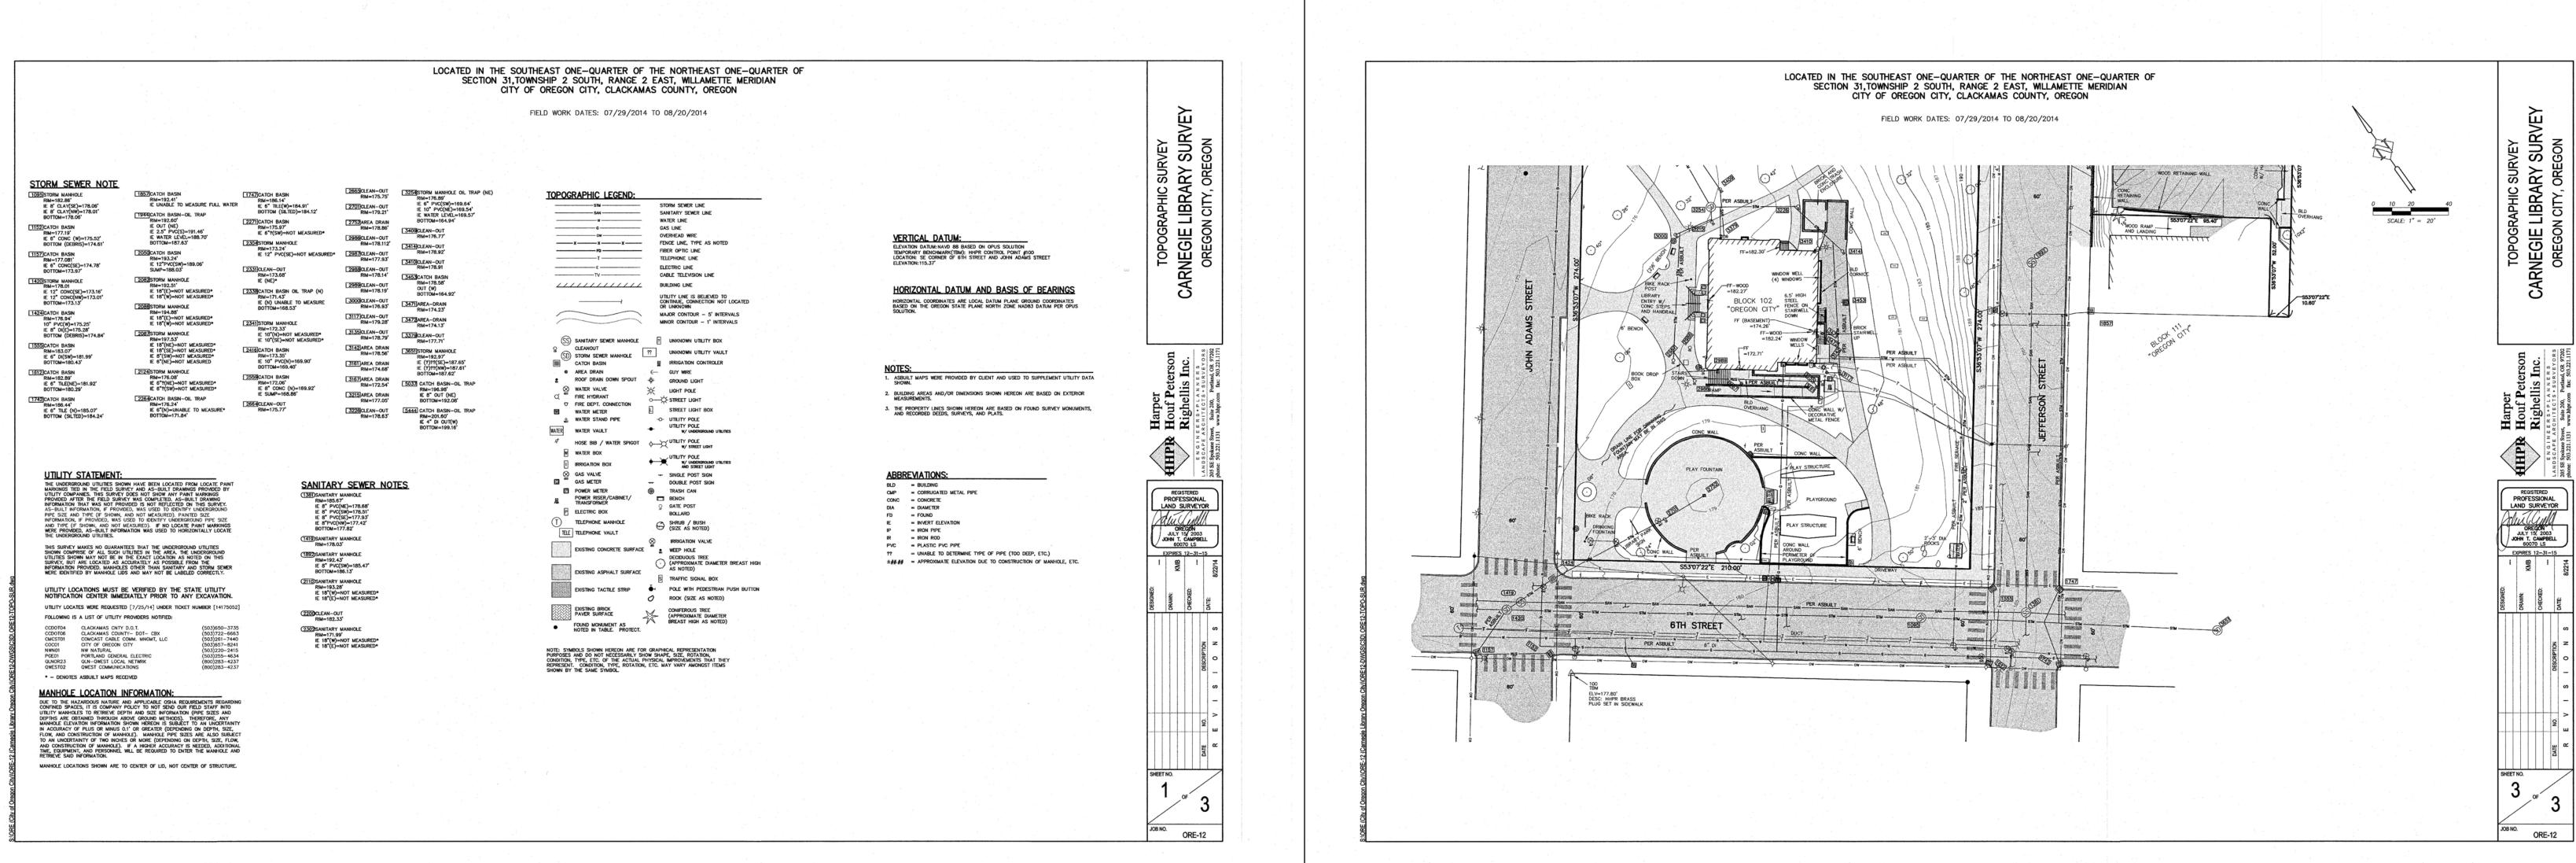

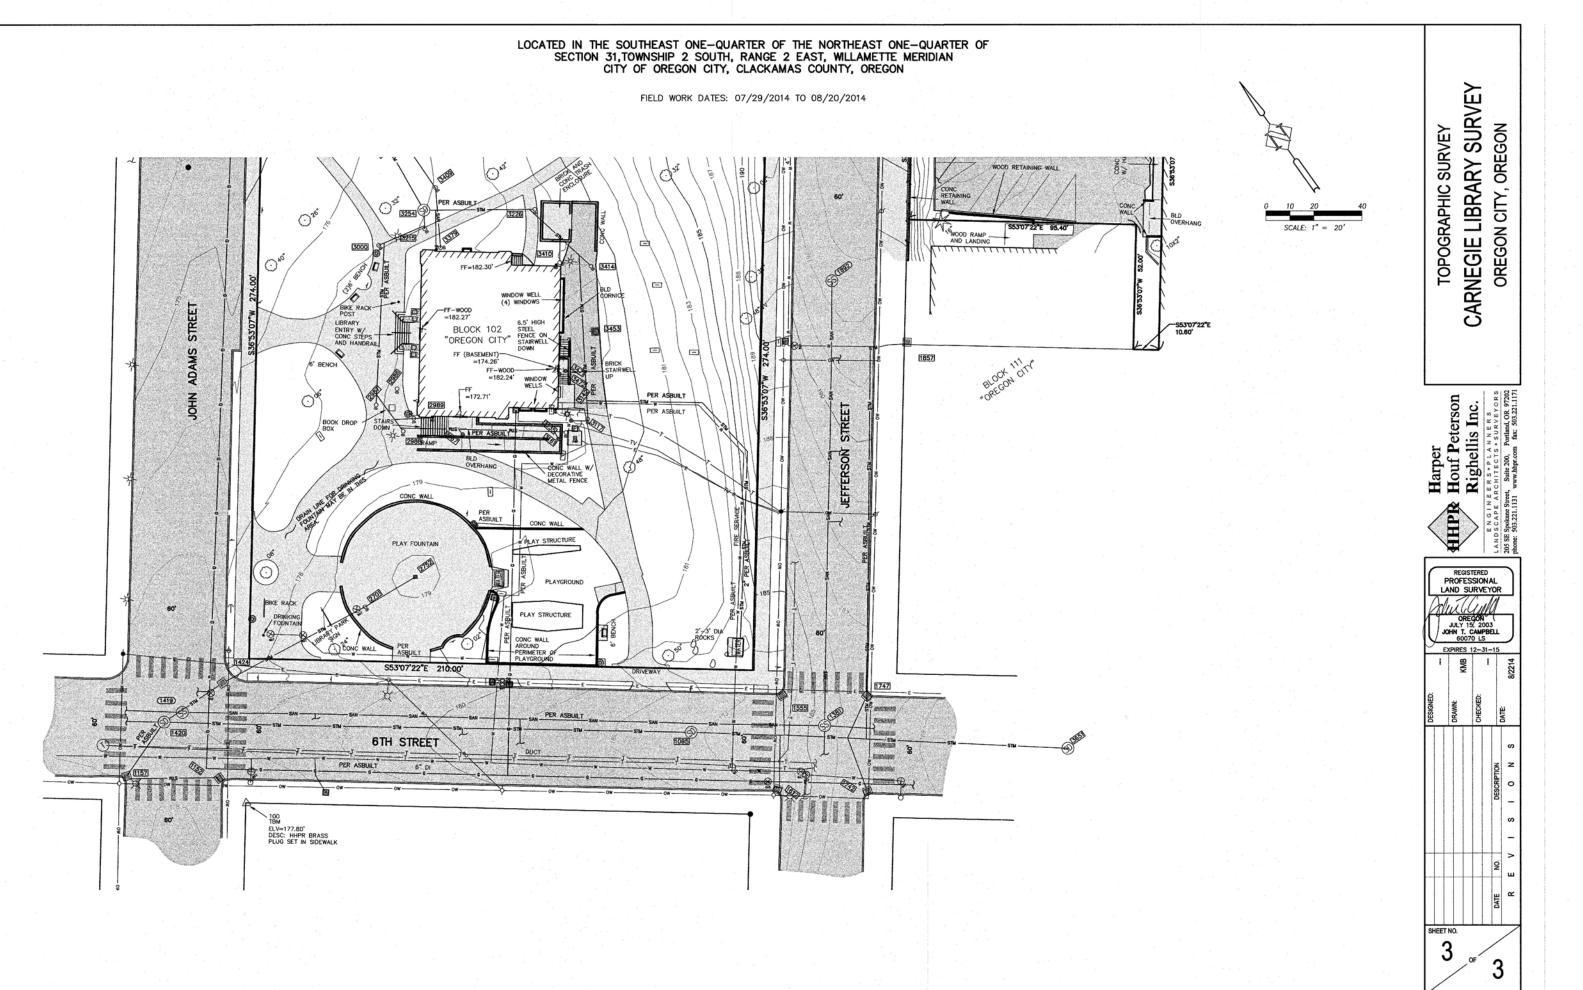

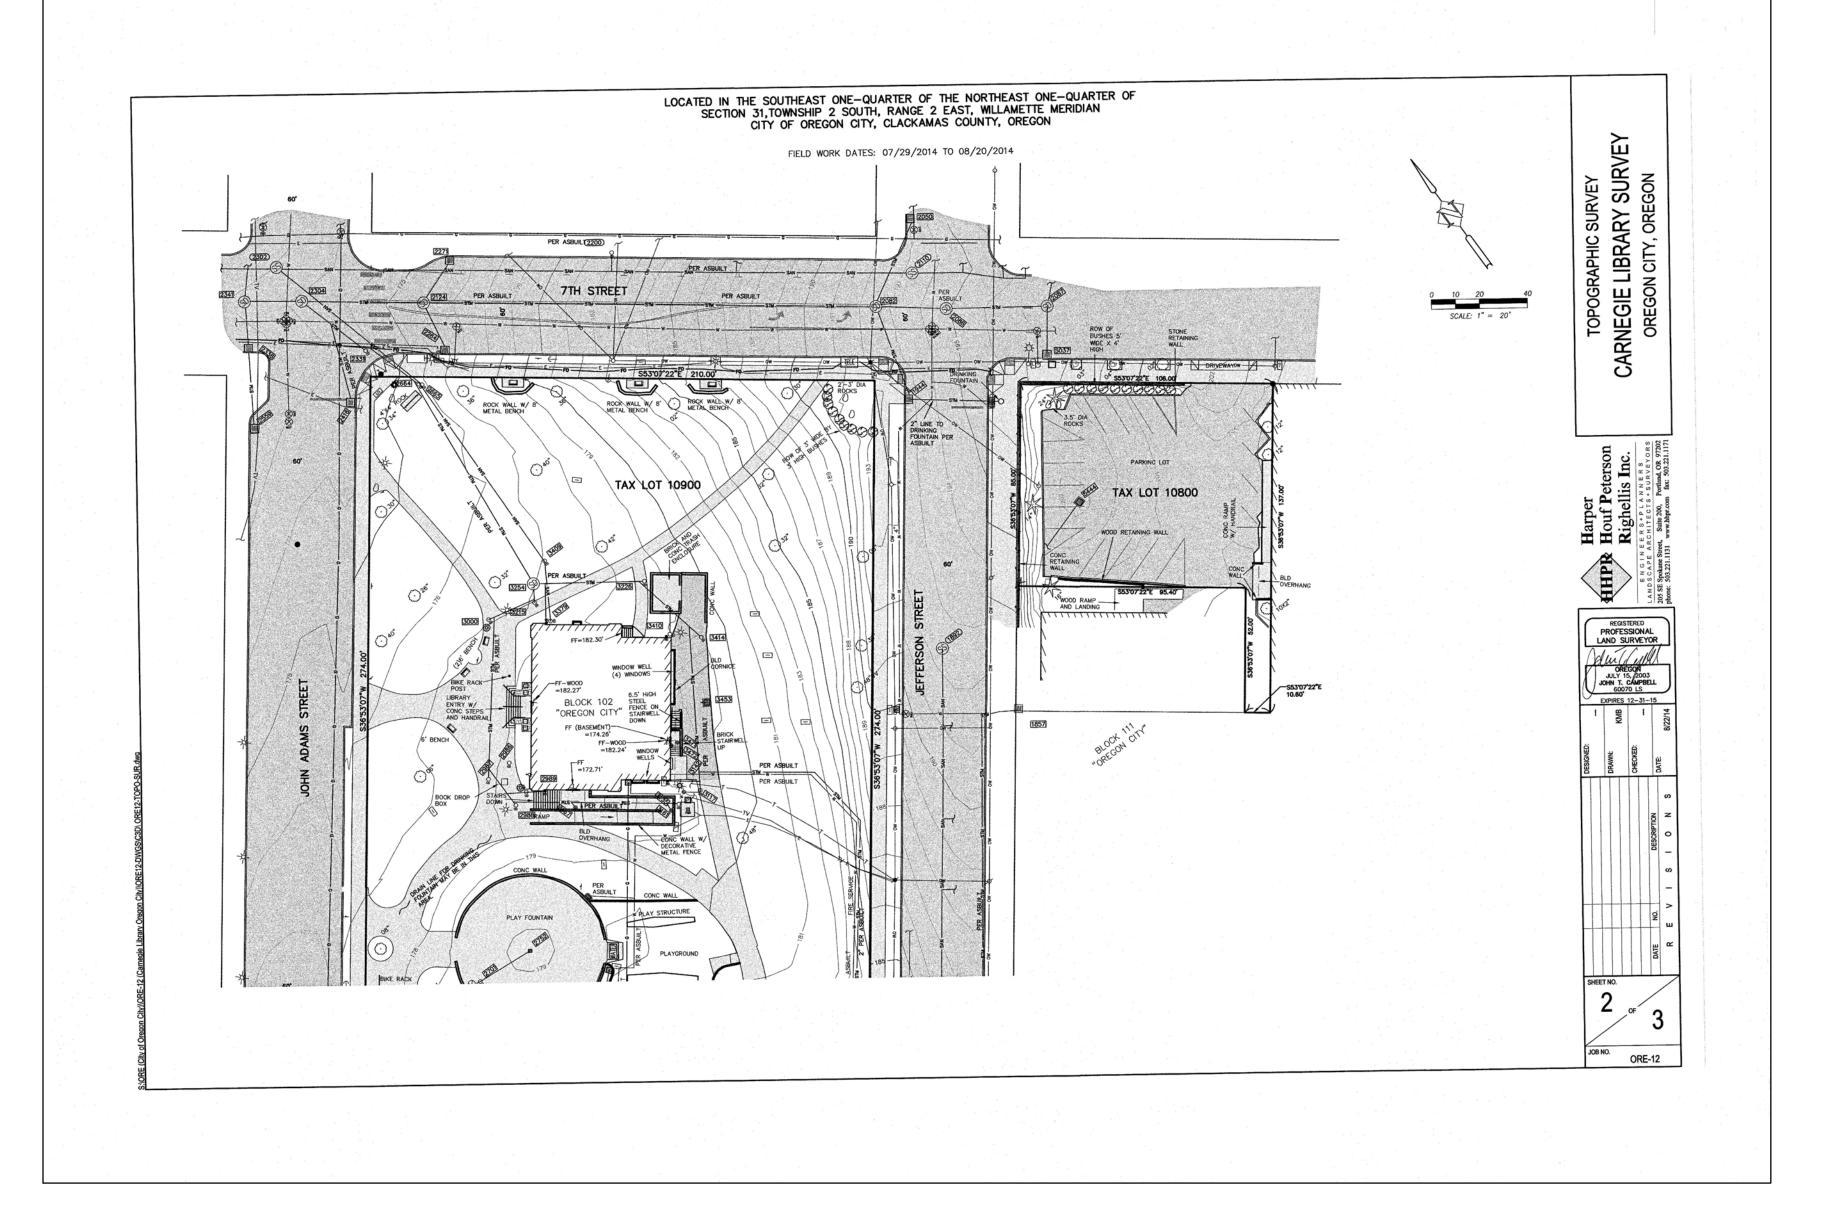


SITE PLAN DESIGN REVIEW & HISTORIC DESIGN REVIEW SUBMITTAL PACKAGE

SURVEY

Sheet No:

REFERENCE ONLY

Drawn By: Checked By:

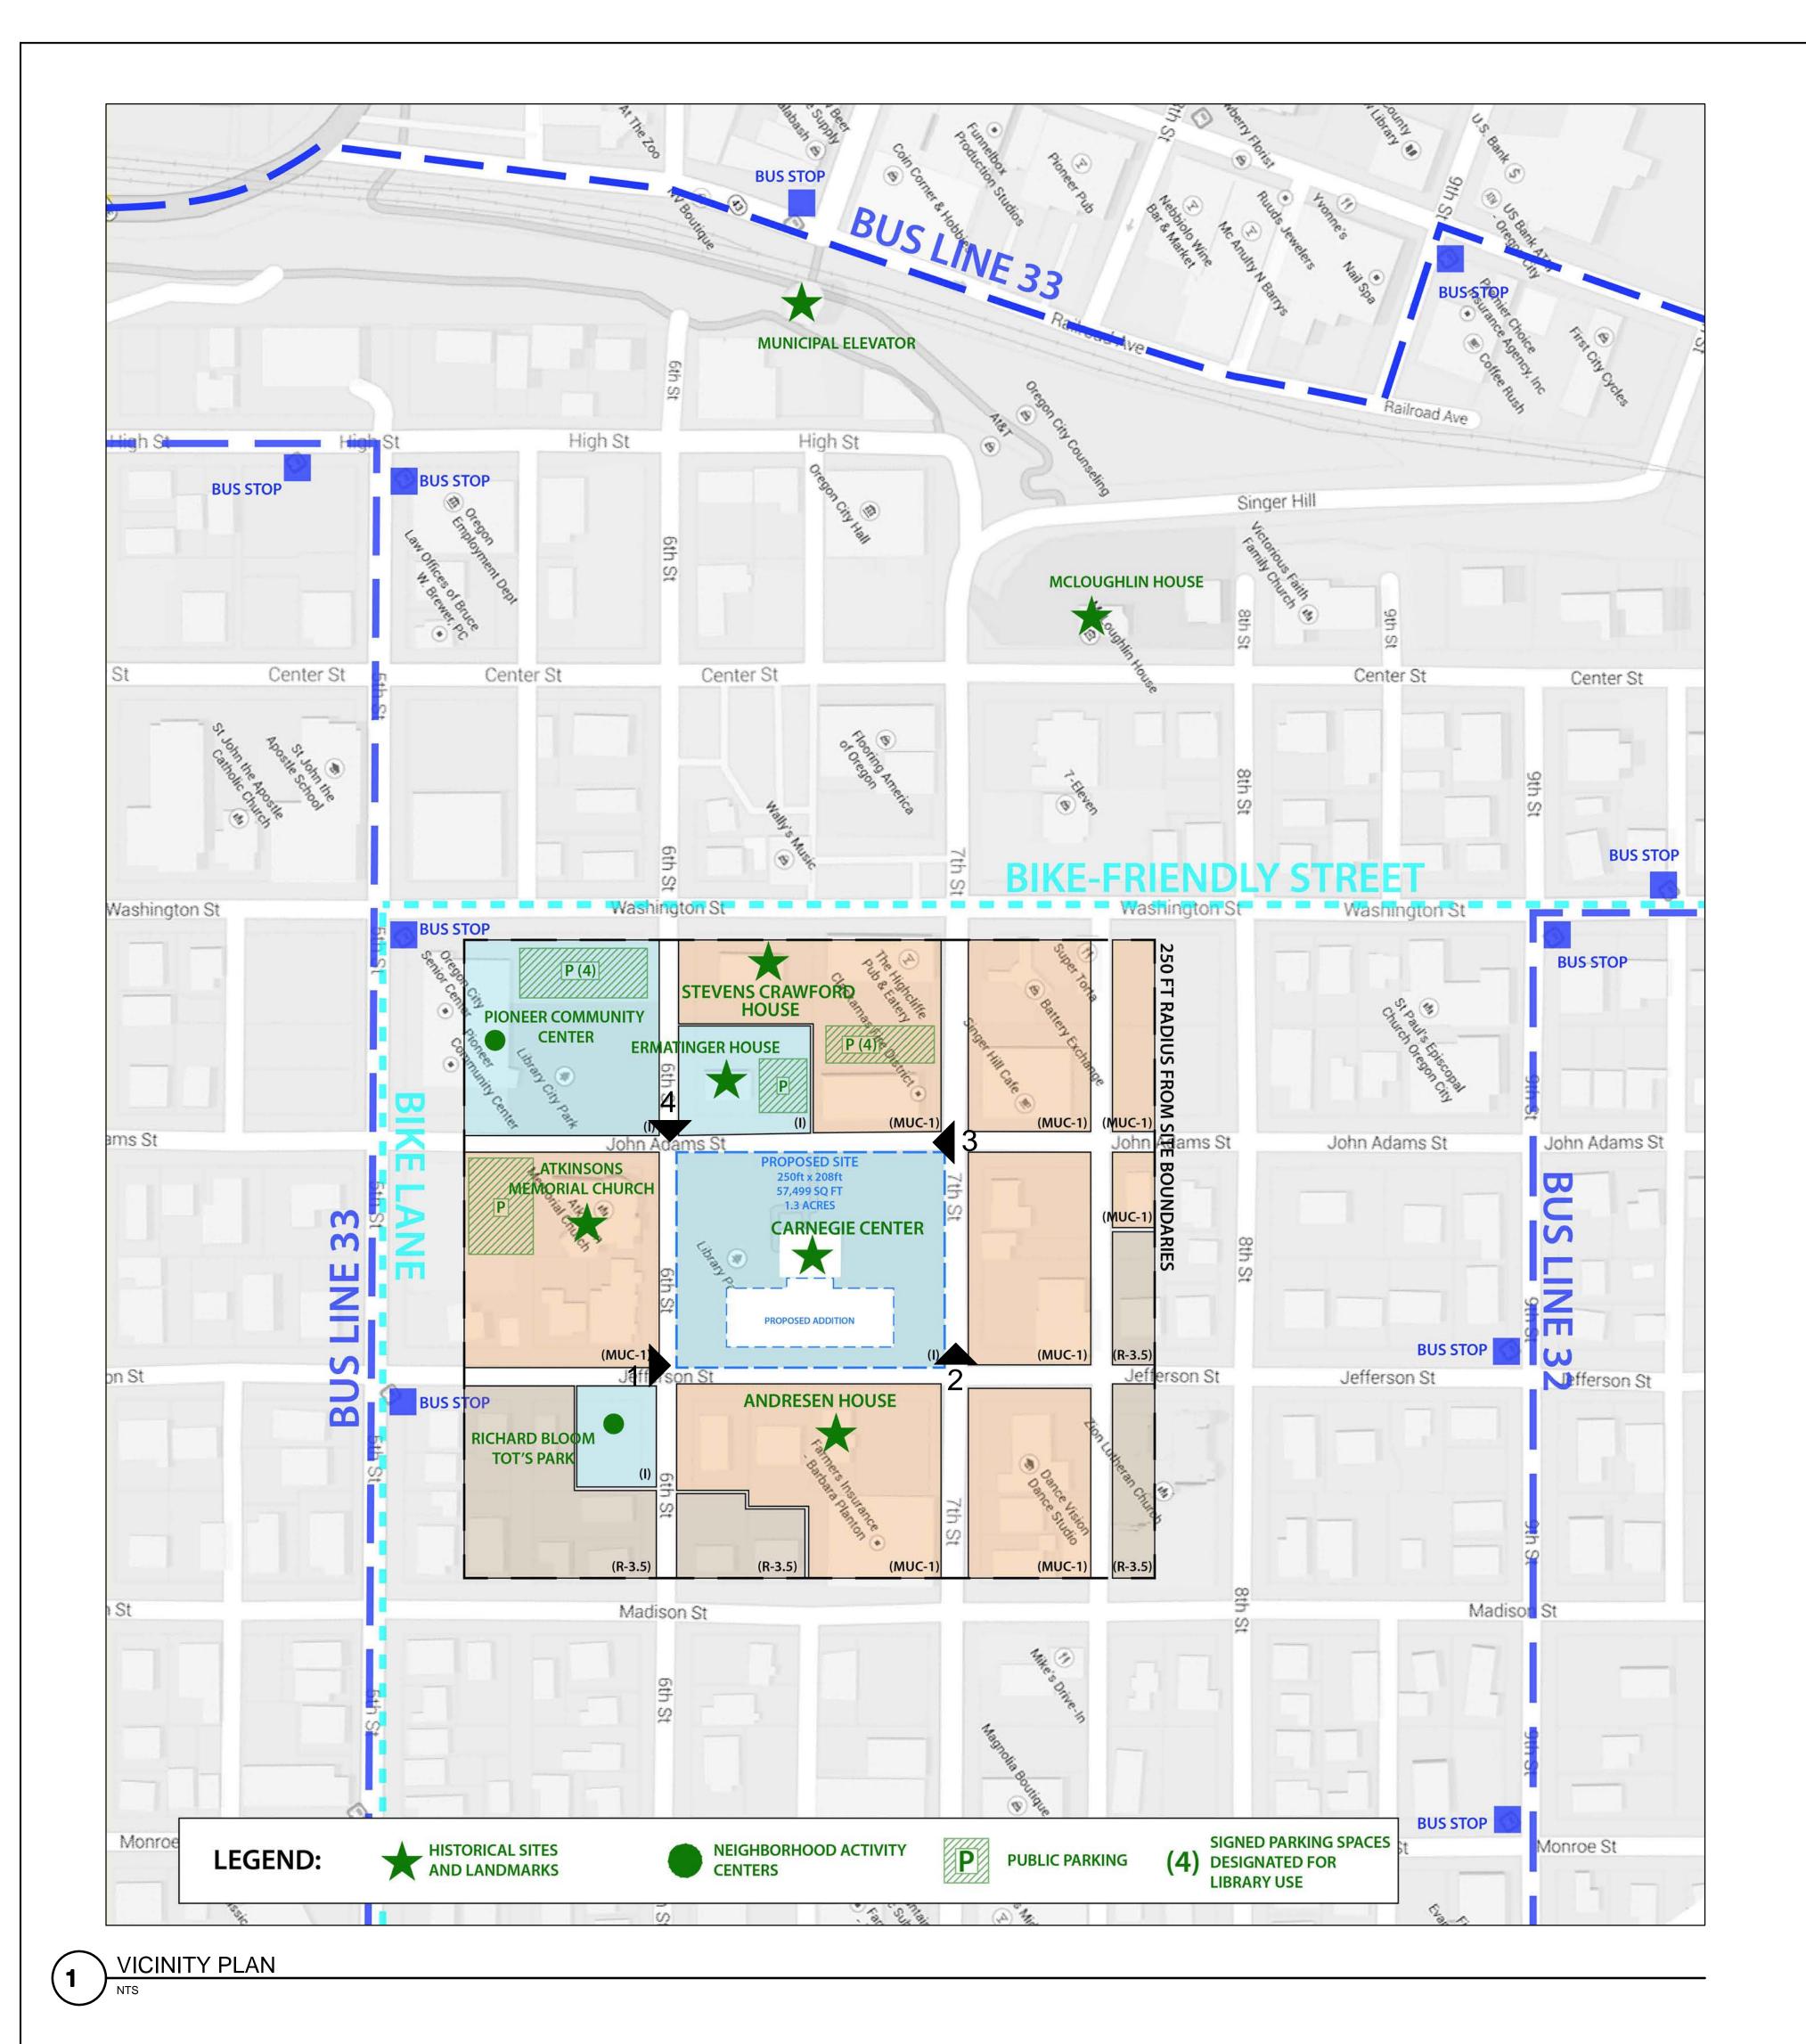




FROM JEFFERSON ST AND 6TH

NTS



FROM JEFFERSON STREET AND 7TH

NTS

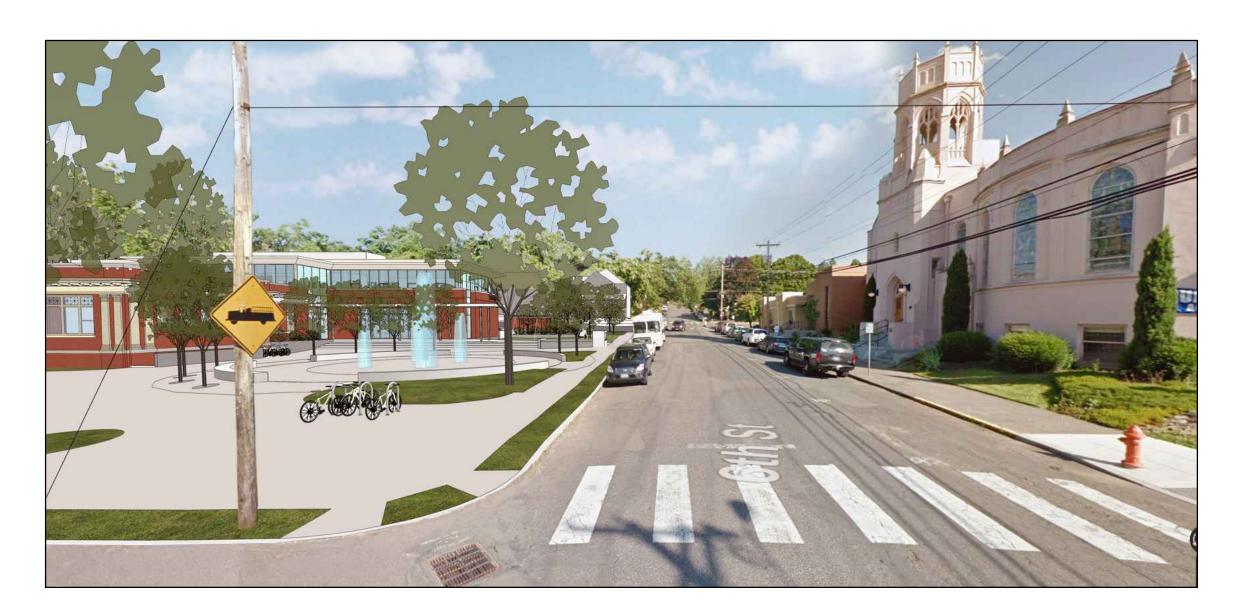

FROM JOHN ADAMS STREET AND 7TH

NTS



FROM JOHN ADAMS STREET AND 6TH

NTS

SCOTT EDWARDS ARCHITECTURE LLP.

2525 E. Burnside St., Portland, OR 97214
phone:(503) 226-3617 www.seallp.com

OREGON CITY
PUBLIC LIBRARY
RENOVATION &
ADDITION

OREGON CITY, OREGON

SITE PLAN DESIGN REVIEW &
HISTORIC DESIGN REVIEW
SUBMITTAL PACKAGE

Drawing:
VICINITY PLAN

CONTEXT INFO

Sheet No:

Job No:

Date:

Drawn By:

Checked By:

A O C





2525 E. Burnside St., Portland, OR 97214 phone:(503) 226-3617 www.seallp.com

OREGON CITY PUBLIC LIBRARY **RENOVATION & ADDITION**

OREGON CITY, OREGON

FROM JOHN ADAMS STREET AND 7 TH STREET

NTS



FROM JOHN ADAMS STREET AND 6 TH STREET

NTS



FROM 6 TH STREET AT MAIN ENTRY

NTS



FROM JEFFERSON STREET AND 7TH STREET

NTS



SITE PLAN DESIGN REVIEW & HISTORIC DESIGN REVIEW SUBMITTAL PACKAGE

Drawing:
RENDERINGS

1415 Drawn By: Checked By: Sheet No:

FROM SECOND FLOOR LOOKING AT ATRIUM AND THE CARNEGIE


NTS


EXISTING MATERIALS







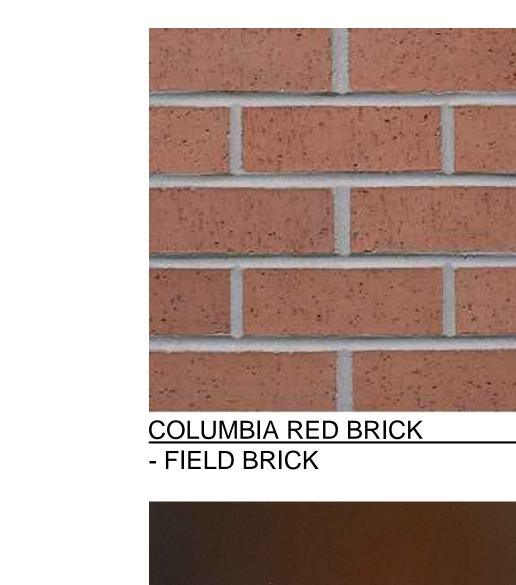

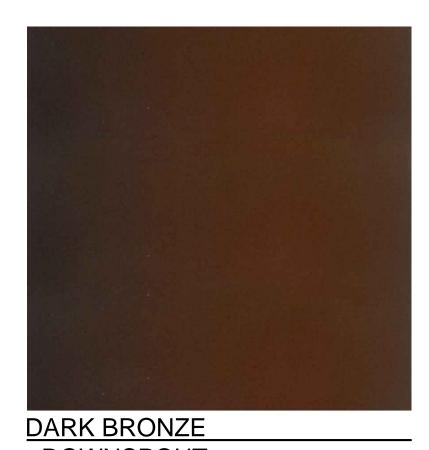

- DOWNSPOUT
- RAILINGS
- SIGNAGE



SEATTLE CREAM BRICK
- DETAIL BRICK



- WOOD WINDOW PAINT





OREGON CITY PUBLIC LIBRARY **RENOVATION & ADDITION**

OREGON CITY, OREGON


PROPOSED ADDITION MATERIALS



PROPOSED ADDITION





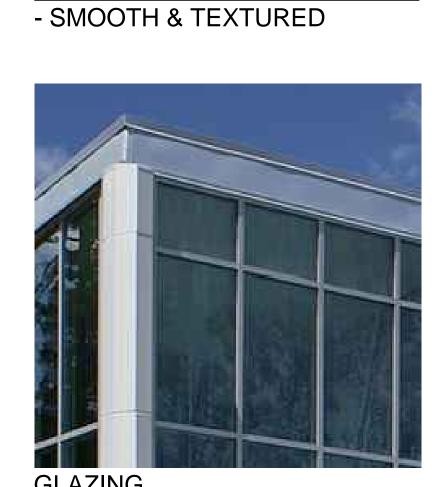

RUBY RED BRICK


<u>GLAZING</u>



LIGHT FIXTURES

PRECAST CONCRETE - SILL CAPS

- COPING

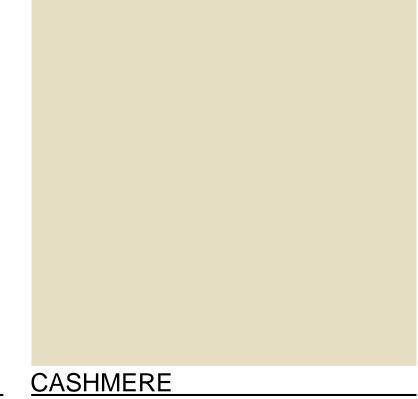

- STOREFRONT FINISH

- PRE-FINISHED METAL PANEL - PAINTED METAL WORK

SITE PLAN DESIGN REVIEW & HISTORIC DESIGN REVIEW SUBMITTAL PACKAGE


BUILDING MATERIAL SAMPLES

Job No: JANUARY 23, 2015 Drawn By: Checked By: Sheet No:

SITE MATERIALS





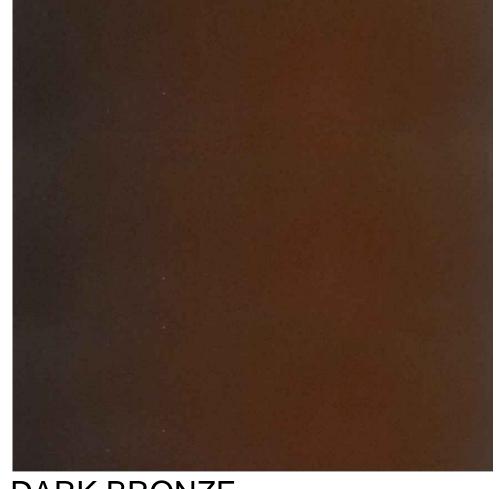

DARK BRONZE

- BIKE RACKS
- SITE LIGHTING
- RAILNGS







SCOTT EDWARDS ARCHITECTURE LLP.

2525 E. Burnside St., Portland, OR 97214 phone:(503) 226-3617 www.seallp.com

OREGON CITY
PUBLIC LIBRARY
RENOVATION &
ADDITION


OREGON CITY, OREGON







BIKE RACKS

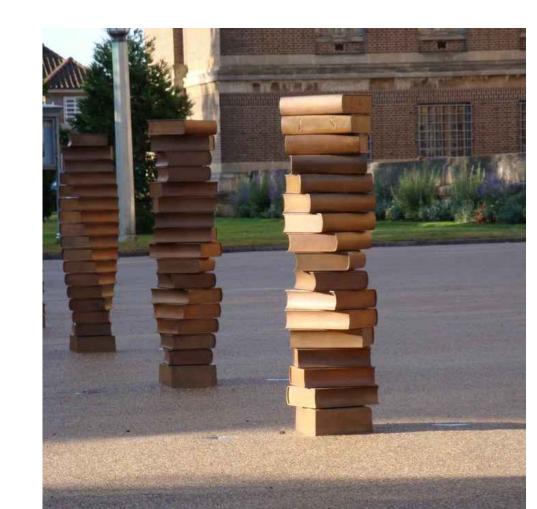

ART



<u>PLAYGROUND</u>



SITE PLAN DESIGN REVIEW &
HISTORIC DESIGN REVIEW
SUBMITTAL PACKAGE

Drawing:
SITE MATERIAL
SAMPLES

Job No: 1415

Date: JANUARY 23, 2015

Drawn By: Checked By: Sheet No:



GREEN ROOF



PHOTOVOLTAIC PANELS



A0.6



205 SE Spokane Street, Suite 200, Portland, OR 97202 phone: 503.221.1131 www.hhpr.com fax: 503.221.1171

LANDSCAPE ARCHITECTS + SURVEYORS

SCOTT EDWARDS ARCHITECTURE LLP 2525 E. Burnside St., Portland, OR 97214 phone:(503) 226-3617 www.seallp.com

OREGON CITY

PUBLIC LIBRARY

RENOVATION &

ADDITION

OREGON CITY, OREGON

PROJECT LOCATION

OREGON CITY PUBLIC LIBRARY 606 JOHN ADAMS STREET OREGON CITY, OREGON 97045 2S 2E 31AD TAX LOT 10900

LATITUDE: 45-21-19 LONGITUDE: -122-36-15

ENGINEER

HARPER HOUF PETERSON RIGHELLIS INC. 205 SE SPOKANE STREET PORTLAND, OREGON 97202 (503) 221-1131 CONTACTS: BRUCE HAUNREITER, P.E.

GENERAL NOTES

1) WORK SHALL CONFORM WITH DEQ AND THE CITY OF OREGON CITY STANDARDS. THE INTERNATIONAL BUILDING CODE (IBC), AND THE UNIFORM PLUMBING CODE (UPC).

2) THE LOCATION AND DESCRIPTIONS OF EXISTING UTILITIES SHOWN ARE COMPILED FROM GUARANTEE THE ACCURACY NOR THE COMPLETENESS OF SUCH RECORDS. EXISTING TOPOGRAPHIC INFORMATION SHOWN IS BASED ON SURVEY PERFORMED BY NW SURVEYORS, INC.

3) THE CONTRACTOR SHALL COMPLY WITH ALL REQUIREMENTS OF ORS 757.541 TO 757.571. THE CONTRACTOR SHALL NOTIFY EACH UNDERGROUND UTILITY AT LEAST 48 BUSINESS-DAY HOURS PRIOR TO EXCAVATING, BORING, OR POTHOLING. ALL UTILITY CROSSINGS SHALL BE POTHOLED AS NECESSARY PRIOR TO EXCAVATING OR BORING TO ALLOW THE CONTRACTOR TO PREVENT GRADE OR ALIGNMENT CONFLICTS.

5) ELEVATIONS ARE BASED ON HHPR CONTROL POINT #100 LOCATED AT THE SE CORNER ÓF 6TH STREET AND JOHN ADAMS STREET. THE BENCHMARK HAS AN ELEVATION OF

6) PROVISIONS SHALL BE MADE BY THE CONTRACTOR TO KEEP ALL EXISTING UTILITIES

7) CONSTRUCTION OF PUBLIC STREET, WATER, SANITARY SEWER, AND STORM DRAINAGE FACILITIES SHALL BE PER CITY OF OREGON CITY STANDARDS.

EROSION AND SEDIMENT CONTROL NOTES:

1) THE CONTRACTOR SHALL BE RESPONSIBLE FOR PROPER INSTALLATION AND WITH LOC CHAPTER 52, STATE, AND FEDERAL REGULATIONS. ALL EROSION AND THE EROSION PREVENTION AND SEDIMENT CONTROL PLANNING AND DESIGN MANUAL, DECEMBER 2000.

4) THE ESC FACILITIES SHOWN ON THIS PLAN ARE MINIMUM REQUIREMENTS FOR ÁNTICIPATED SITE CONDITIONS. DURING CONSTRUCTION PERIOD, THESE ESC FACILITIES SHALL BE UPGRADED AS NEEDED FOR UNEXPECTED STORM EVENTS AND TO ENSURE THAT SEDIMENT AND SEDIMENT-LADEN WATER DOES NOT LEAVE THE SITE.

HEIGHT OF SEDIMENT FENCES.

PAVEMENT SURFACES ARE COMPLETED AND/OR VEGETATION IS RE-ESTABLISHED. INLET PROTECTION MEASURES SHALL BE IN PLACE DURING SAW CUTTING ACTIVITIES.

THE CLEANING OPERATIONS SHALL NOT FLUSH SEDIMENT-LADEN WATER INTO THE STORM

10) TEMPORARY GRASS COVER MEASURES MUST BE FULLY ESTABLISHED BY OCTOBER 1ST. FROM OCTOBER 1ST THROUGH APRIL 30TH, THE WET WEATHER EROSION PREVENTION MEASURES WILL BE IN EFFECT FOR ANY EXPOSED SOIL OR SOILS NOT FULLY ESTABLISHED. SEE THE EROSION AND SEDIMENT CONTROL MANUAL (CHAPTER 4) FOR REQUIREMENTS. ALL STOCKPILED SEDIMENT WILL BE COVERED WITH PLASTIC SHEETING AND ISOLATED WITH SILT FENCING OR CHECK DAM AT THE TOE OF SLOPE WHEN NOT IN USE. ALL NEWLY EXPOSED SOILS WILL BE PROTECTED WITH AN ADEQUATE GROUND COVER AT THE END OF CONSTRUCTION EACH DAY. (STRAW, MULCH, COMPOST, WOOD

11) THE OWNER SHALL REMOVE ESC MEASURES WHEN VEGETATION IS FULLY ESTABLISHED.

12) IN AREAS SUBJECT TO SURFACE AND AIR MOVEMENT OF DUST, WHERE ON-SITE OR OFF-SITE DAMAGE IS LIKELY TO OCCUR, ONE OR MORE OF THE FOLLOWING PREVENTATIVE MEASURES SHALL BE TAKEN FOR DUST CONTROL:

- TEMPORARY STABILIZATION PRACTICES.
- B. THE SITE IS SPRINKLED WITH WATER UNTIL SURFACE IS WET. REPEAT AS NEEDED TO PREVENT THE CARRY OUT OF MUD ONTO STREET, REFER TO STABILIZED
- C. SPRAY EXPOSED SOILS WITH A DUST PALLIATIVE. NOTE, USED OIL IS PROHIBITED AS A PALLIATIVE.

13) STOCKPILES THAT WILL BE EXPOSED FOR MORE THAN 14 DAYS SHALL BE PROTECTED WITH PLASTIC SHEETING OR WITH A TEMPORARY GROUND COVER USED IN CONJUNCTION WITH TEMPORARY/PERMANENT SEEDING. STOCKPILES THAT CONTAIN ONLY STRIPPINGS SHALL BE IMMEDIATELY COVERED WITH PLASTIC SHEETING. SEDIMENT FENCES SHALL BE

AVAILABLE RECORDS AND/OR FIELD SURVEYS. THE CITY OR UTILITY COMPANIES DO NOT

4) A SITE SPECIFIC GEOTECHNICAL INVESTIGATION HAS BEEN PERFORMED. THE CONTRACTOR SHALL ENSURE THAT SITE CONSTRUCTION COMPLIES WITH THE CONCLUSIONS AND RECOMMENDATIONS CONTAINED IN THE PROJECT GEOTECHNICAL

115.37 FEET (NAVD 88 DATUM).

TO REMAIN IN SERVICE AND PROTECT THEM DURING CONSTRUCTION.

MAINTENANCE OF ALL EROSION AND SEDIMENT CONTROL MEASURES, IN ACCORDANCE SEDIMENT CONTROL MEASURES SHALL BE INSTALLED, INSPECTED, AND MAINTAINED PER

2) THE IMPLEMENTATION OF THESE ESC PLANS AND CONSTRUCTION, MAINTENANCE, RÉPLACEMENT, AND UPGRADING OF THESE ESC FACILITIES IS THE RESPONSIBILITY OF THE CONTRACTOR UNTIL ALL CONSTRUCTION IS COMPLETED AND APPROVED BY THE LOCAL JURISDICTION, AND VEGETATION/LANDSCAPING IS ESTABLISHED. THE OWNER SHALL BE RESPONSIBLE FOR MAINTENANCE AFTER THE PROJECT IS APPROVED UNTIL VEGETATION/LANDSCAPING IS ESTABLISHED.

3) THE ESC FACILITIES SHOWN ON THIS PLAN MUST BE CONSTRUCTED IN CONJUNCTION WITH ALL CLEARING AND GRADING ACTIVITIES, AND IN SUCH A MANNER AS TO INSURE THAT SEDIMENT AND SEDIMENT LADEN WATER DOES NOT ENTER THE DRAINAGE SYSTEM. ROADWAYS, OR VIOLATE APPLICABLE WATER STANDARDS.

5) AT NO TIME SHALL SEDIMENT BE ALLOWED TO ACCUMULATE MORE THAN 1/3 THE

6) STORM DRAIN INLETS, BASINS, AND AREA DRAINS SHALL BE PROTECTED UNTIL

7) ALL CATCH BASINS AND CONVEYANCE LINES SHALL BE CLEANED PRIOR TO PAVING. WATER MANAGEMENT SYSTEM.

8) PAVEMENT SURFACES AND VEGETATION ARE TO BE PLACED AS RAPIDLY AS POSSIBLE.

9) PUBLIC STREETS WILL BE SWEPT DAILY, IF NECESSARY, TO ALLEVIATE SEDIMENT DISCHARGE TO THE STORM WATER MANAGEMENT SYSTEM. UNFILTERED WASH WATER CANNOT BE DISCHARGED TO STORM DRAINS.

CHIPS, PLASTIC SHEETING, ETC.).

A. MINIMIZE THE PERIOD OF SOIL EXPOSURE THROUGH THE USE OF TEMPORARY GROUND COVER AND OTHER

- CONSTRUCTION ENTRANCE DETAILS.

PLACED AT THE TOE OF SLOPE OF ALL STOCKPILES.

SITE PLAN DESIGN REVIEW & HISTORIC DESIGN REVIEW SUBMITTAL PACKAGE

GRADING & EROSION CONTROL PLAN

- INSTALL NEW CURB JEFFERSON STREET

· INSTALL INLET PROTECTION

PROPOSED RAMP

1' R.O.W. DEDICATION

– EXISTING CONCRETE – SPLASH PARK TO

PROPOSED CONTOUR

\ (TYP)\ \ [

— PROPOSED RAMP

& CURB

& CURB

.....

.....

PROPOSED CURB -

PROPOSED -

10' WALK -

ADA RAMP ·

PROPOSED HC

PARKING

(4 STALLS)

FLUSH CURB WITH -

PROPOSED CURB -

INSTALL INLET

PROTECTION

& SIDEWALK

TACTILE WARNING

(TYPICAL)

PARKING

& SIDEWALK

JOHN ADAMS STREET

MATCH EXISTING

M

EXISTING BUILDING TO REMAIN FFE 182.30

PROPOSED ADDITION

PROPOSED STORMWATER

PLANTER .

FFE 182.30

GRADE

— PROPOSED CONCRETE WALK

- PROPOSED

FACILITY

STORMWATER

INSTALL INLET -

— 1' R.O.W. DEDICATION

EXIŞTING SIDEWALK TO REMAIN

PROPERTY LINE

- 1' R.O.W.

INSTALL INLET —

PROTECTION

DEDICATION


202

—— ow — ∞

INSTALL SEDIMENT

FENCE /

PROTECTION

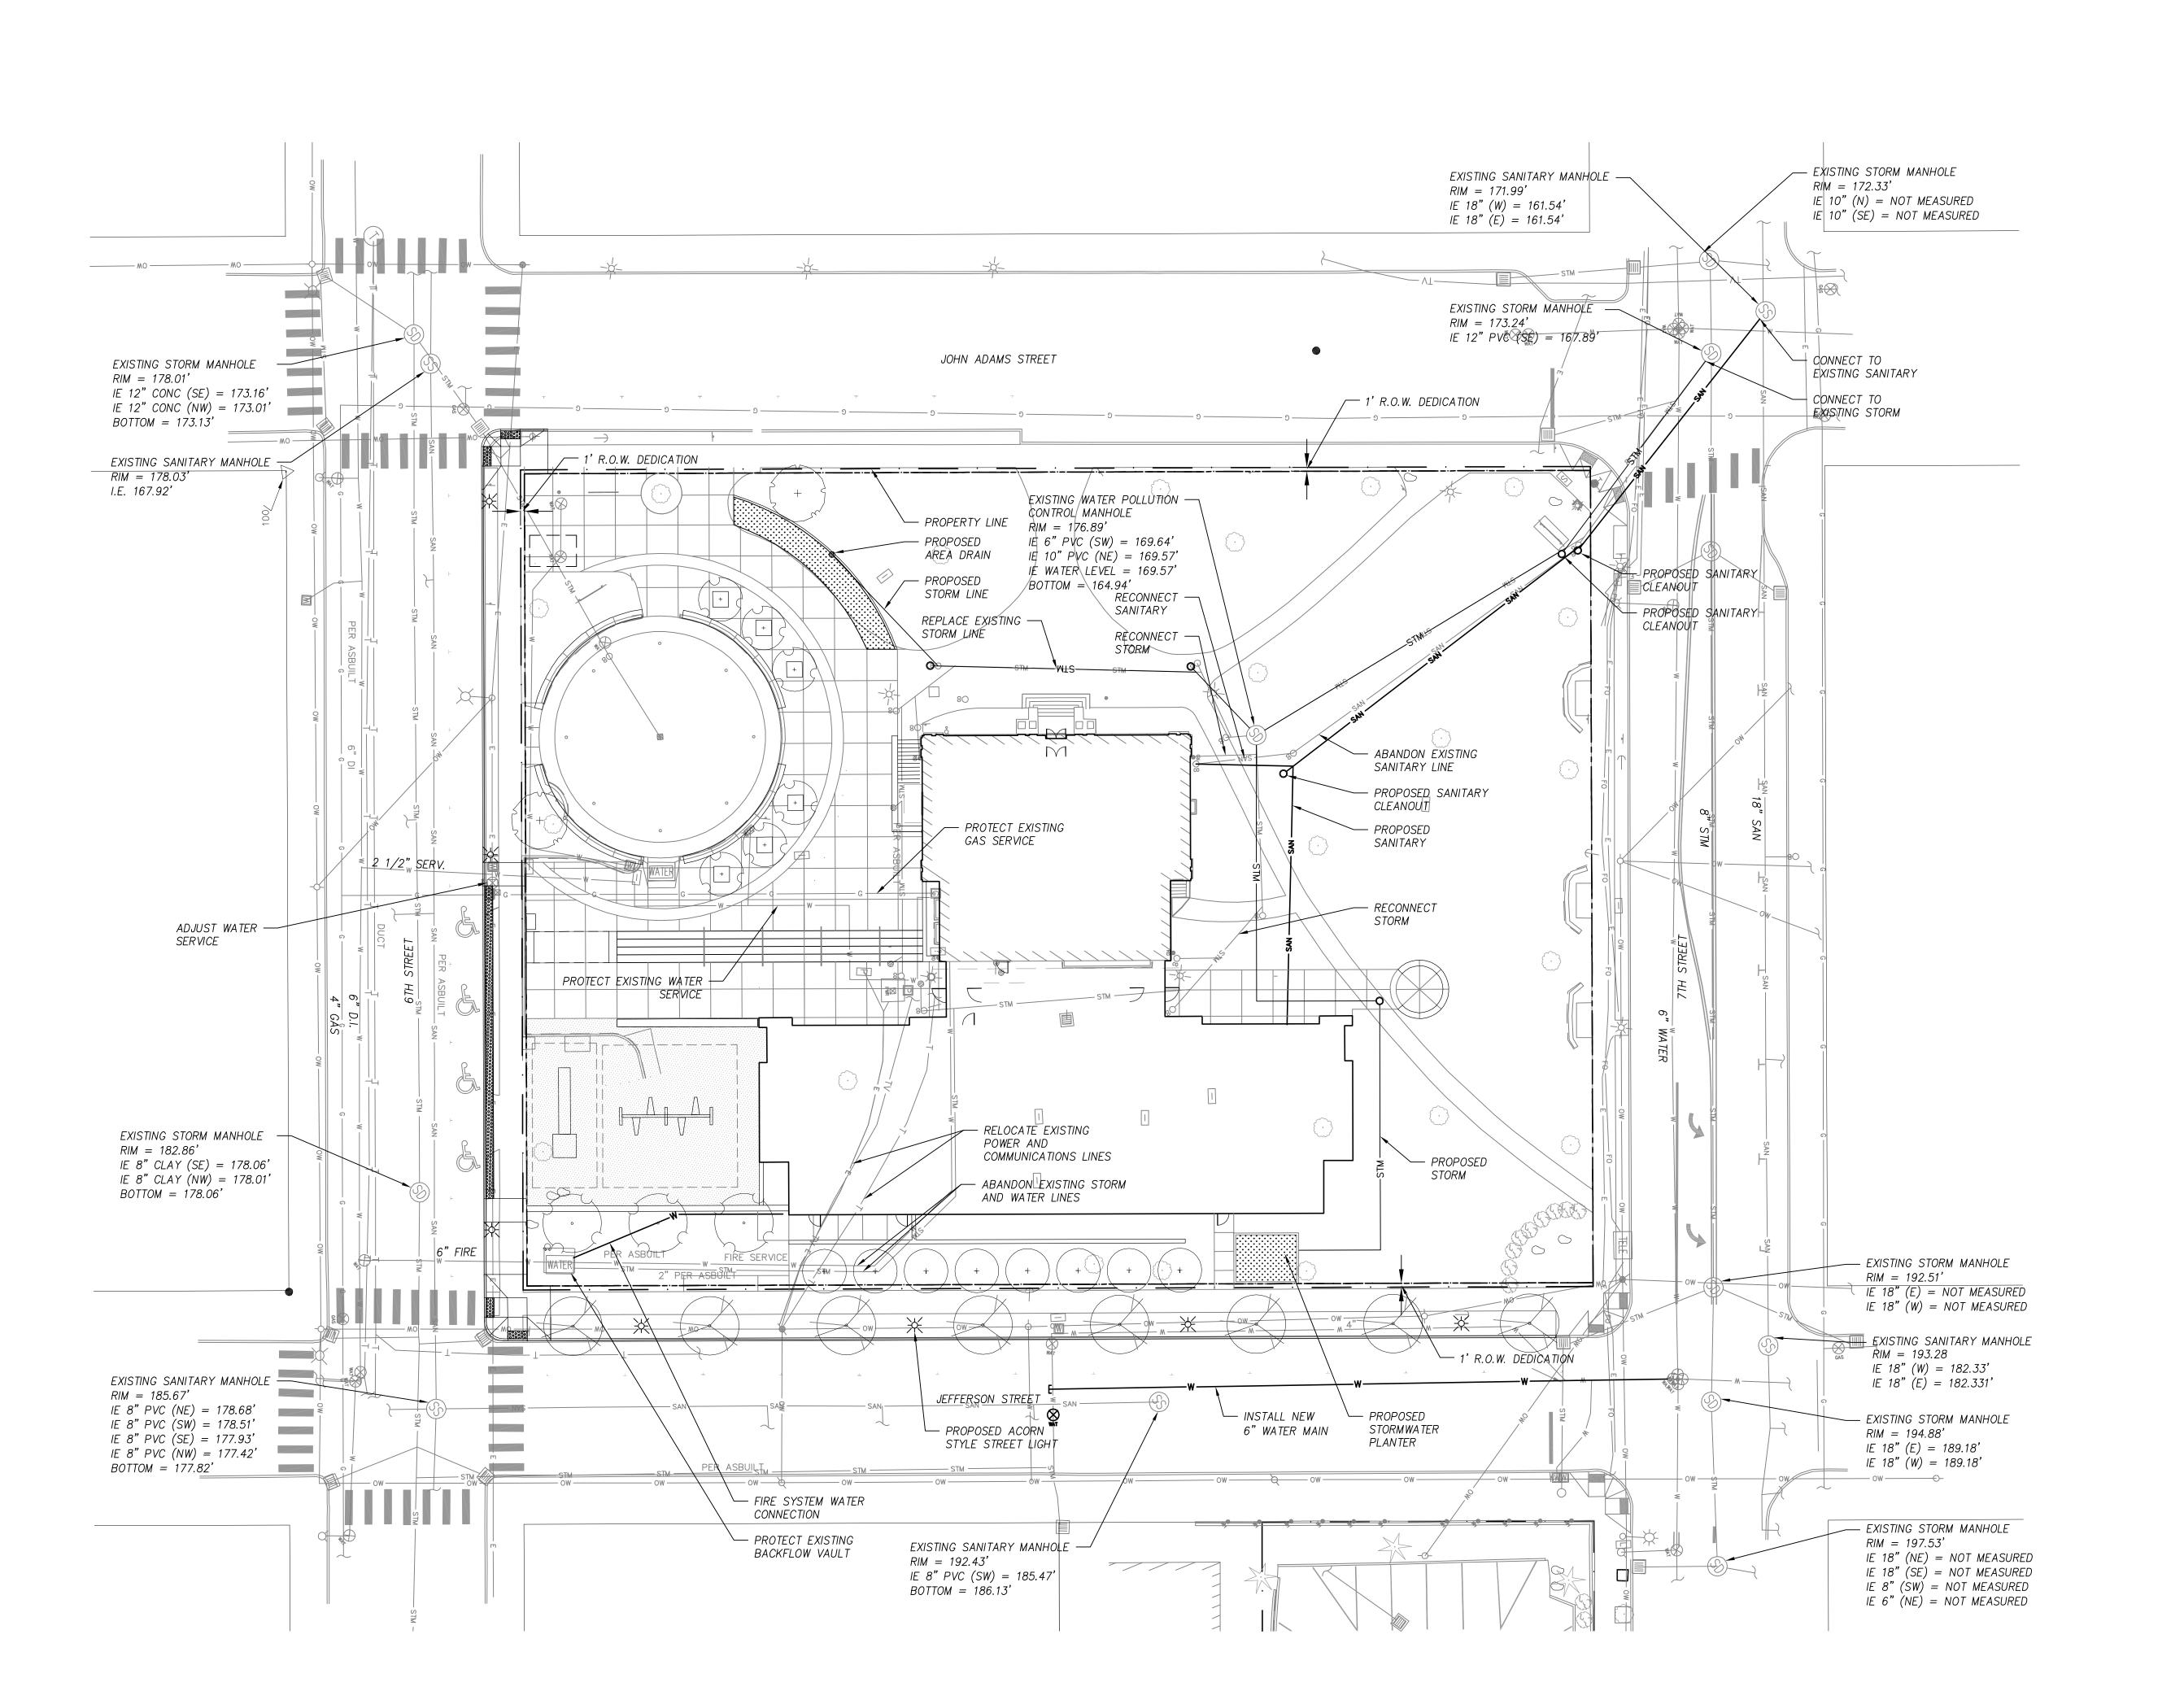



LANDSCAPE ARCHITECTS * SURVEYORS 205 SE Spokane Street, Suite 200, Portland, OR 97202 phone: 503.221.1131 www.hhpr.com fax: 503.221.1171

GENERAL NOTES

1) WORK SHALL CONFORM WITH DEQ AND THE OREGON CITY STANDARDS, THE INTERNATIONAL BUILDING CODE (IBC), AND THE UNIFORM PLUMBING CODE (UPC).

2) THE LOCATION AND DESCRIPTIONS OF EXISTING UTILITIES SHOWN ARE COMPILED FROM AVAILABLE RECORDS AND /OR FIELD SURVEYS. THE CITY OR UTILITY COMPANIES DO NOT GUARANTEE THE ACCURACY NOR THE COMPLETENESS OF SUCH RECORDS. EXISTING TOPOGRAPHIC INFORMATION SHOWN IS BASED ON SURVEY PERFORMED BY HHPR.

3) THE CONTRACTOR SHALL COMPLY WITH ALL REQUIREMENTS OF ORS 757.541 TO 757.571. THE CONTRACTOR SHALL NOTIFY EACH UNDERGROUND UTILITY AT LEAST 48 BUSINESS-DAY HOURS PRIOR TO EXCAVATING, BORING, OR POTHOLING. ALL UTILITY CROSSINGS SHALL BE POTHOLED AS NECESSARY PRIOR TO EXCAVATING OR BORING TO ALLOW THE CONTRACTOR TO PREVENT GRADE OR ALIGNMENT CONFLICTS.

4) A SITE SPECIFIC GEOTECHNICAL INVESTIGATION HAS BEEN PERFORMED. THE CONTRACTOR SHALL ENSURE THAT SITE CONSTRUCTION COMPLIES WITH THE CONCLUSIONS AND RECOMMENDATIONS CONTAINED IN THE PROJECT GEOTECHNICAL

5) BASIS OF BEARINGS AND BOUNDARY DETERMINATION ARE FROM FOUND MONUMENTS AND RECORD INFORMATION.

6) PROVISIONS SHALL BE MADE BY THE CONTRACTOR TO KEEP ALL EXISTING UTILITIES TO REMAIN IN SERVICE AND PROTECT THEM DURING CONSTRUCTION.

7) CONSTRUCTION OF PUBLIC STREET, WATER, SANITARY SEWER, AND STORM DRAINAGE FACILITIES SHALL BE PER CITY OF PORTLAND STANDARDS.

STORM DRAINAGE SYSTEM

STORM DRAIN PIPE, BENDS, AND FITTINGS SHALL BE PVC (ASTM 3034, SDR 35 OR C-900), OR SMOOTH INTERIOR HIGH DENSITY POLYETHYLENE CORRUGATED PIPE AS PRODUCED AND SPECIFIED BY ADS, PRODUCT NAME N12(TM), OR EQUIVALENT, UNLESS OTHERWISE SPECIFIED ON PLANS.

STORM PIPE WITH LESS THAN 3' OF COVER AND LOCATED IN VEHICLE TRAVEL AREAS SHALL BE PVC TYPE C-900.

PRIOR TO TESTING AND INSPECTION OF THE STORM SYSTEM, ALL PARTS OF THE SYSTEM SHALL BE CLEANED OF ALL DEBRIS.

TESTING OF STORM PIPELINE SHALL BE IN ACCORDANCE WITH OREGON CITY REQUIREMENTS.

WATER SYSTEM

ALL PIPE SHALL HAVE 36" MINIMUM COVER MEASURED FROM FINISH GRADE.

ALL WATERLINE WORK IN PUBLIC RIGHT-OF-WAY, INCLUDING METER BUT EXCLUDING WORK ON THE BACKSIDE OF THE DOMESTIC METER, SHALL BE CONSTRUCTED BY OREGON CITY AND COORDINATED BY THE CONTRACTOR. UPON COMPLETION OF THE INSTALLATION OF THE WATER SYSTEM ALL LINES SHALL BE FLUSHED AND DISINFECTED IN CONFORMANCE WITH HEALTH DIVISION GUIDELINES AND CITY REQUIREMENTS. THE CONTRACTOR SHALL TEST ALL LINES PER THE CITY REQUIREMENTS.

PRIVATE DOMESTIC AND FIRE SERVICE LINES 3 1/2" OR SMALLER SHALL BE TYPE K COPPER OR SCHEDULE 40 PVC. LINES 4" OR LARGER SHALL BE CLASS 52 D.I. PIPE OR PVC PRESSURE PIPE (C-900 CLASS 150)

ALL WATER PIPE SHALL COMPLY WITH OREGON CITY, AWWA, AND UL STANDARDS. SANITARY SEWER SYSTEM

SANITARY SEWER CONSTRUCTION SHALL COMPLY WITH UNIFORM PLUMBING CODE AND INTERNATIONAL BUILDING CODE REQUIREMENTS.

MISC. UTILITIES

ELECTRICAL, TELEPHONE, GAS, AND TV SERVICE SHALL BE COORDINATED BY THE CONTRACTOR WITH THE APPROPRIATE UTILITY COMPANY. COORDINATE LOCATION WITH

STORM AND SANITARY IE'S BASED ON AS-BUILT DATA.

SITE PLAN DESIGN REVIEW & HISTORIC DESIGN REVIEW SUBMITTAL PACKAGE

SCOTT EDWARDS ARCHITECTURE LLP

2525 E. Burnside St., Portland, OR 97214

phone:(503) 226-3617 www.seallp.com

OREGON CITY

PUBLIC LIBRARY

RENOVATION &

ADDITION

OREGON CITY, OREGON


UTILITY PLAN & STORM


DRAINAGE PLAN


JANUARY 23, 2015





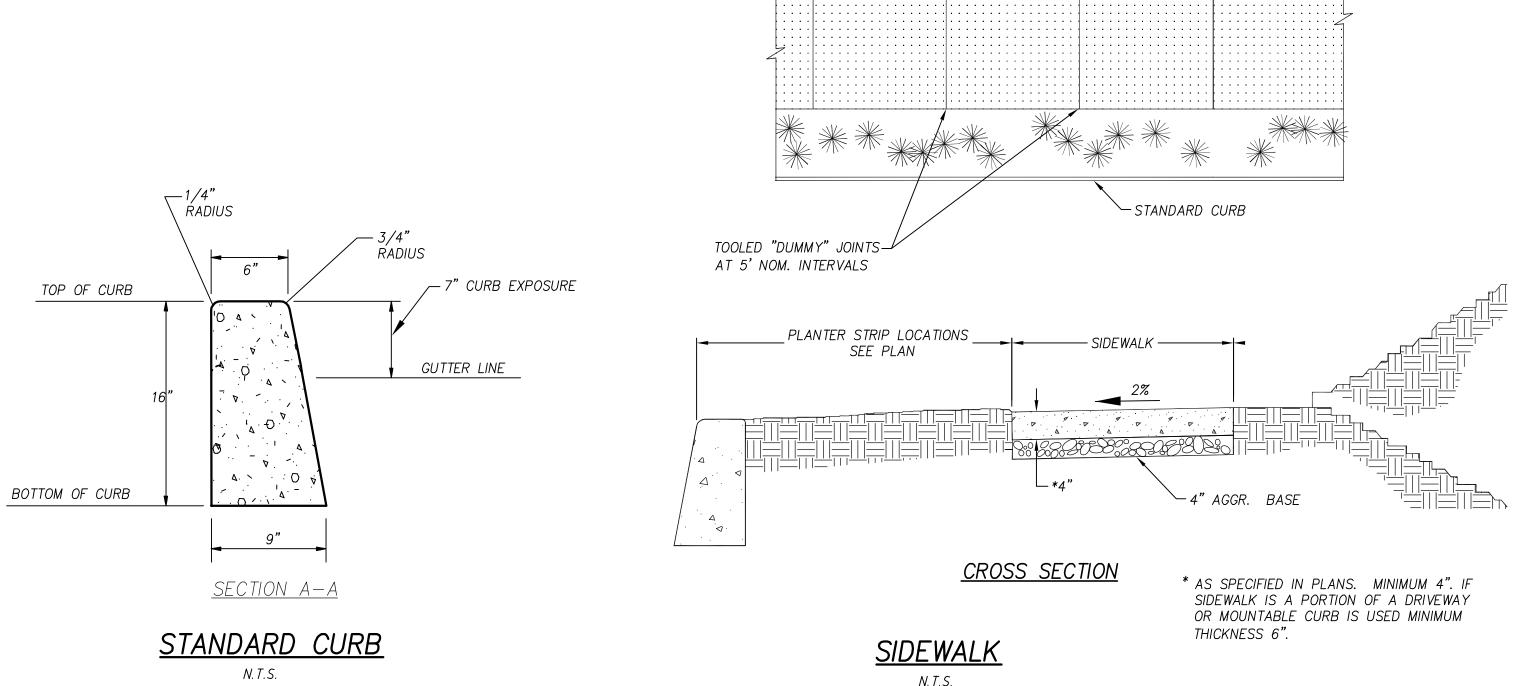

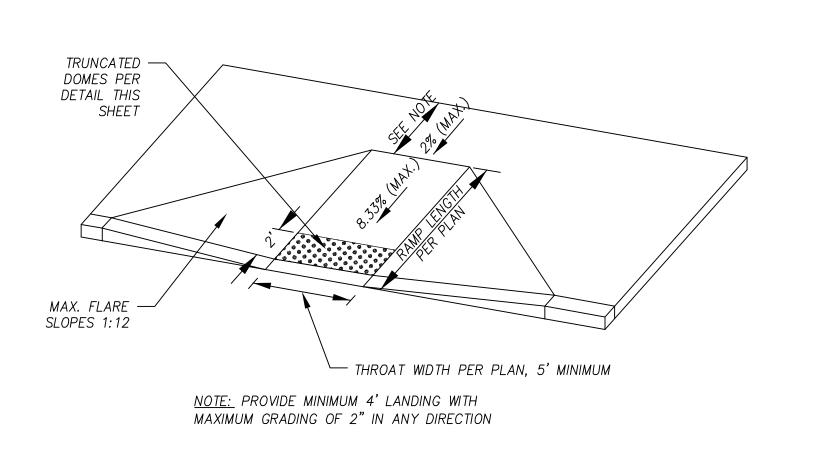

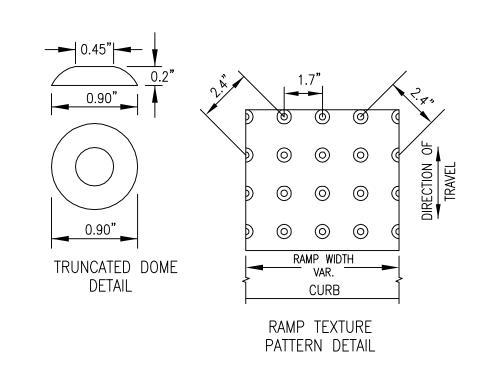



OREGON CITY
PUBLIC LIBRARY
RENOVATION &
ADDITION

OREGON CITY, OREGON




BROOM PATTERN

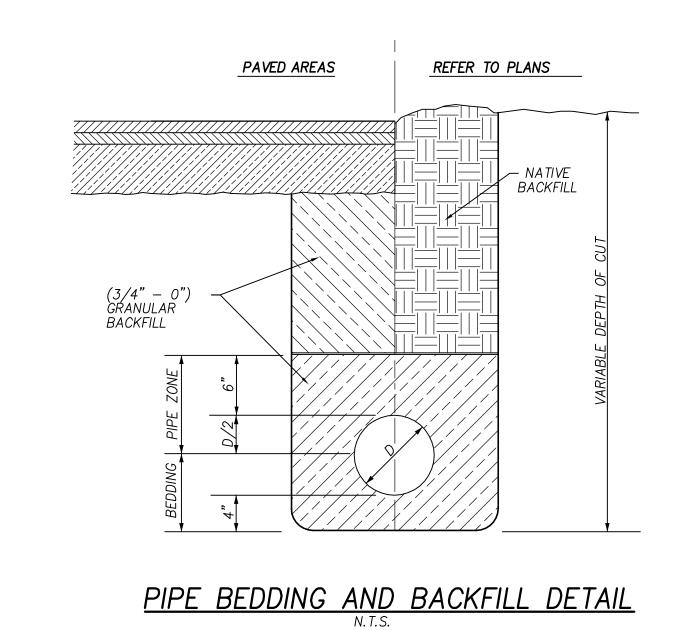


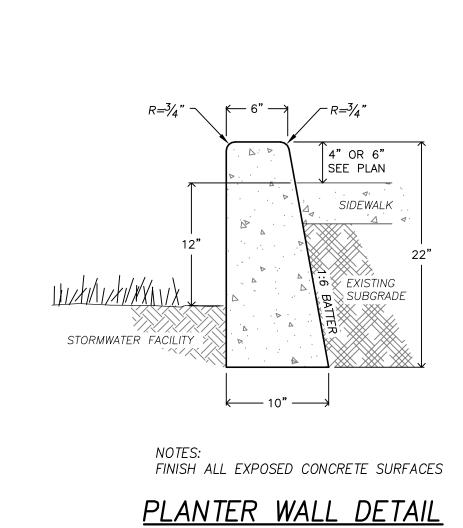

– CONTRACTION JOINTS AT —

APPROXIMATE 15' INTERVALS

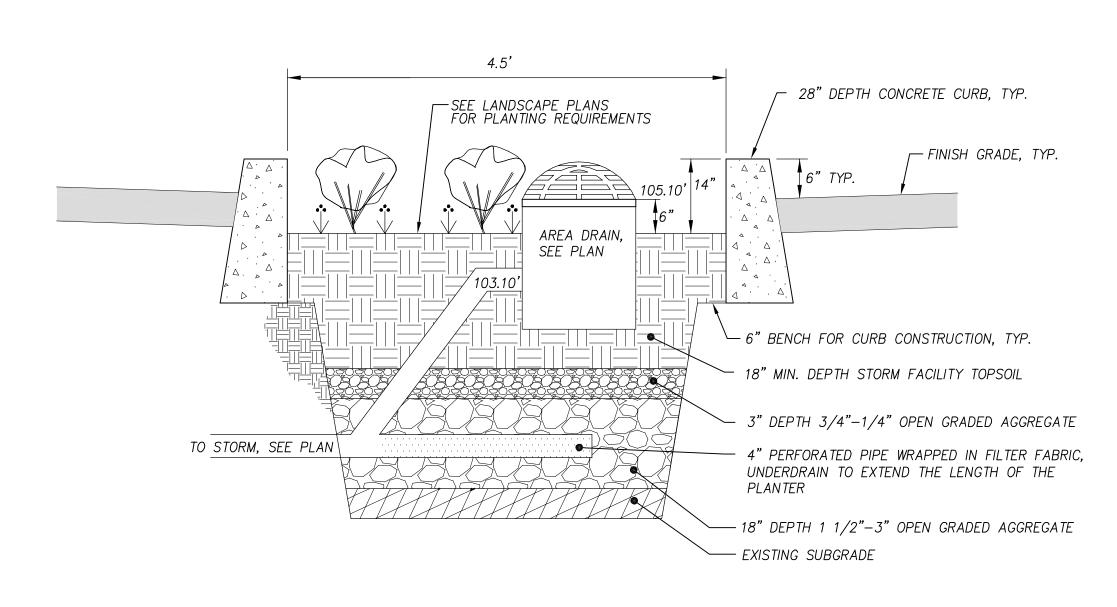

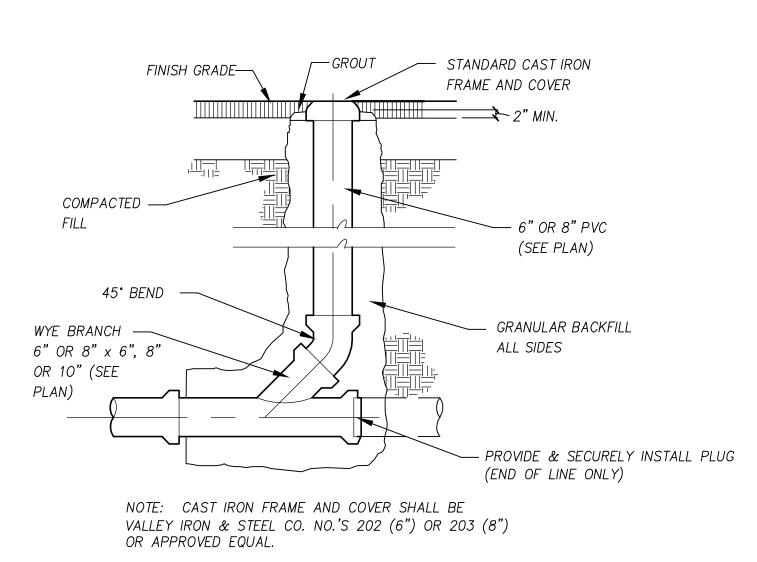


STORMWATER PLANTER SECTION A-A


N.T.S.

STANDARD CLEANOUT

N.T.S.

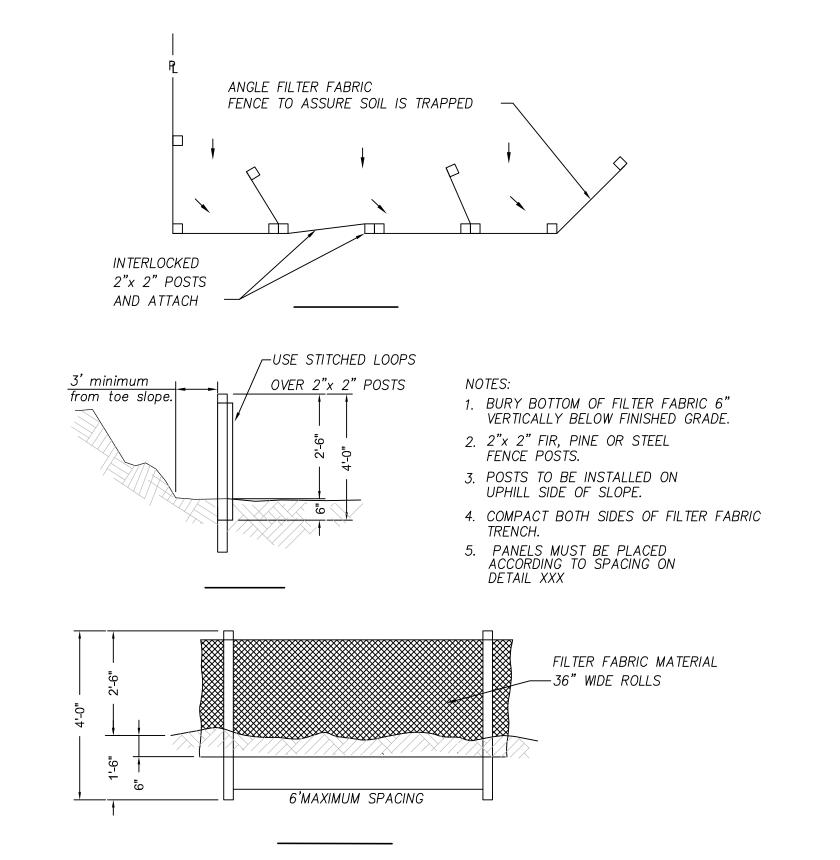

SEDIMENT FENCE
N.T.S.

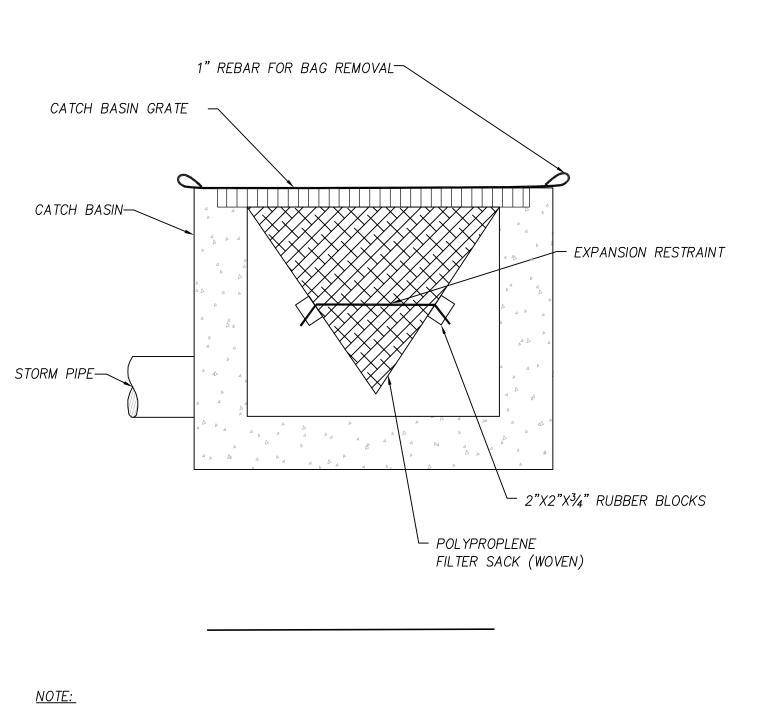

NOTE:

1. RECESSED CURB INLET CATCH BASINS
MUST BE BLOCKED WHEN USING FILTER
FABRIC INLET SACKS. SIZE OF FILTER FABRIC
INLET SACKS TO BE DETERMINED BY
MANUFACTURER.

INLET PROTECTION TYPE 5
N.T.S.

SITE PLAN DESIGN REVIEW &
HISTORIC DESIGN REVIEW
SUBMITTAL PACKAGE


Drawing: **DETAILS**

Job No: 1415

Date: JANUARY 23, 2015

Drawn By:
Checked By:
Sheet No:

C3.1

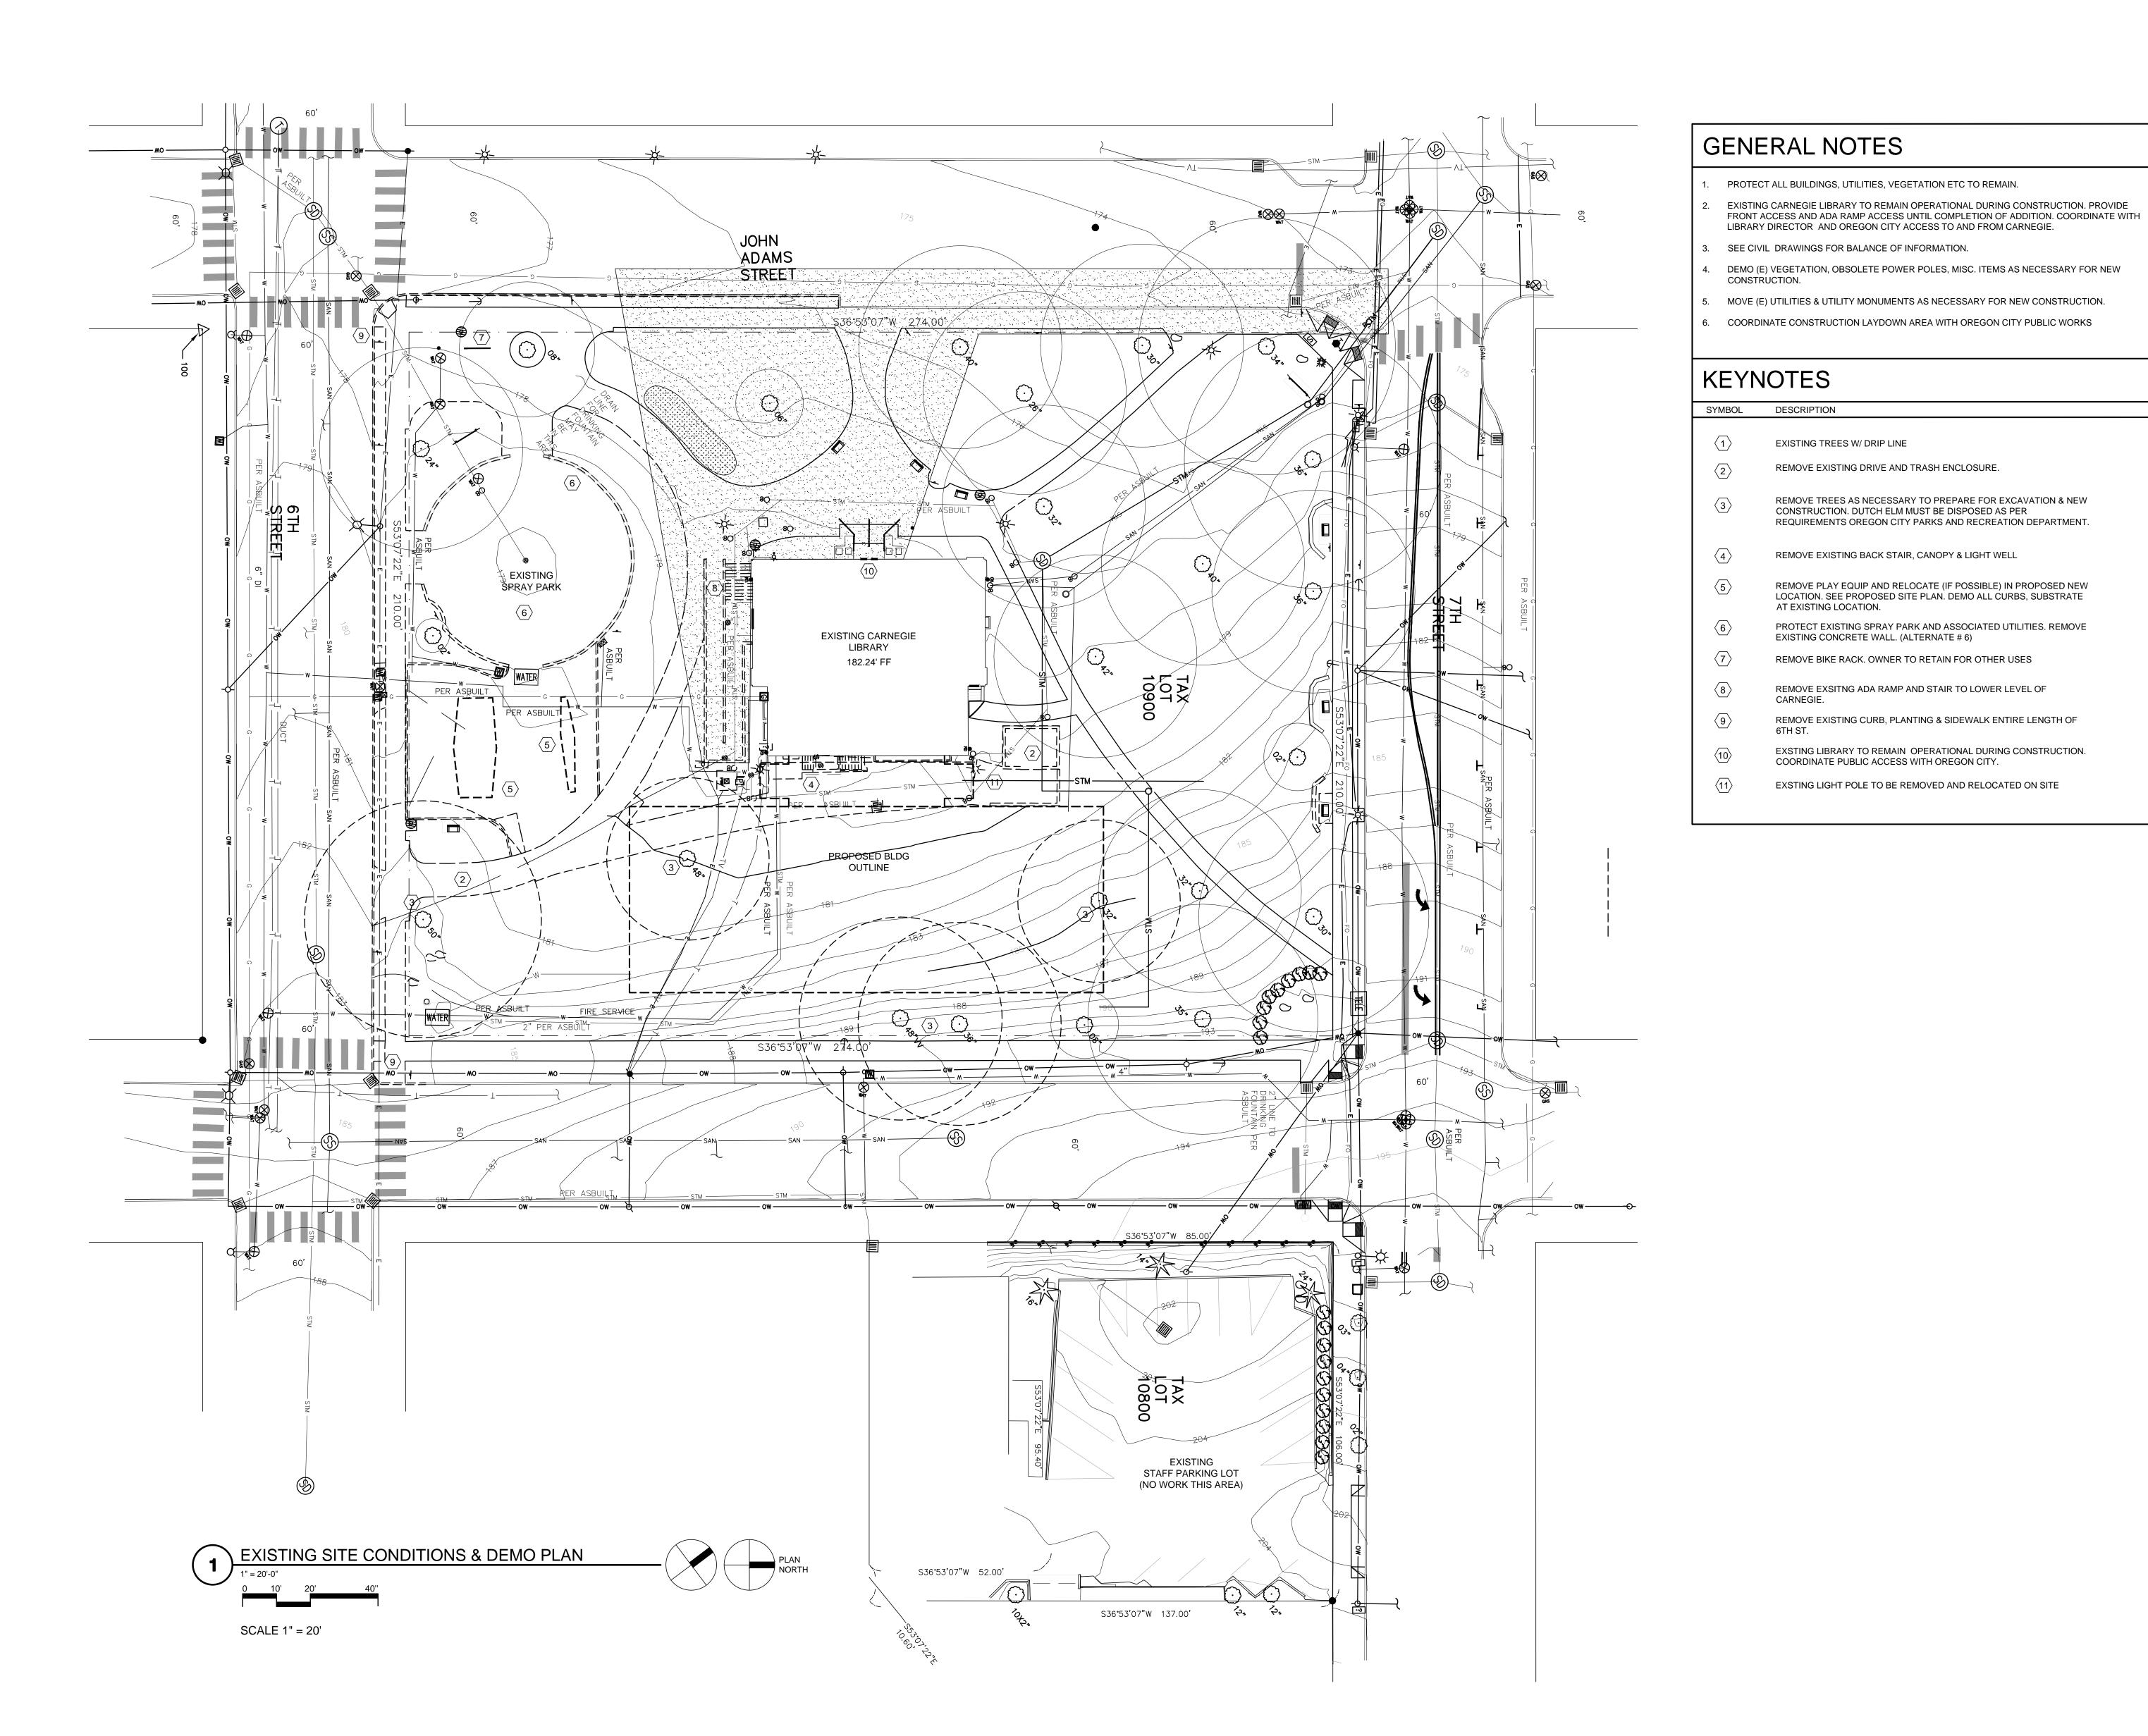



OREGON CITY PUBLIC LIBRARY **RENOVATION & ADDITION**

OREGON CITY, OREGON

EXISTING TREES W/ DRIP LINE

AT EXISTING LOCATION.

REMOVE EXISTING DRIVE AND TRASH ENCLOSURE.

CONSTRUCTION. DUTCH ELM MUST BE DISPOSED AS PER

REMOVE EXISTING BACK STAIR, CANOPY & LIGHT WELL

REMOVE BIKE RACK. OWNER TO RETAIN FOR OTHER USES

REMOVE EXSITNG ADA RAMP AND STAIR TO LOWER LEVEL OF

REMOVE EXISTING CURB, PLANTING & SIDEWALK ENTIRE LENGTH OF

EXSTING LIBRARY TO REMAIN OPERATIONAL DURING CONSTRUCTION. COORDINATE PUBLIC ACCESS WITH OREGON CITY.

EXSTING LIGHT POLE TO BE REMOVED AND RELOCATED ON SITE

REMOVE TREES AS NECESSARY TO PREPARE FOR EXCAVATION & NEW

REQUIREMENTS OREGON CITY PARKS AND RECREATION DEPARTMENT.

REMOVE PLAY EQUIP AND RELOCATE (IF POSSIBLE) IN PROPOSED NEW LOCATION. SEE PROPOSED SITE PLAN. DEMO ALL CURBS, SUBSTRATE

PROTECT EXISTING SPRAY PARK AND ASSOCIATED UTILITIES. REMOVE EXISTING CONCRETE WALL. (ALTERNATE # 6)

SITE PLAN DESIGN REVIEW & HISTORIC DESIGN REVIEW SUBMITTAL PACKAGE


EXIST SITE CONDITIONS

& DEMOLITION PLAN

JANUARY 23, 2015 Drawn By: Checked By: Sheet No:



OREGON CITY, OREGON

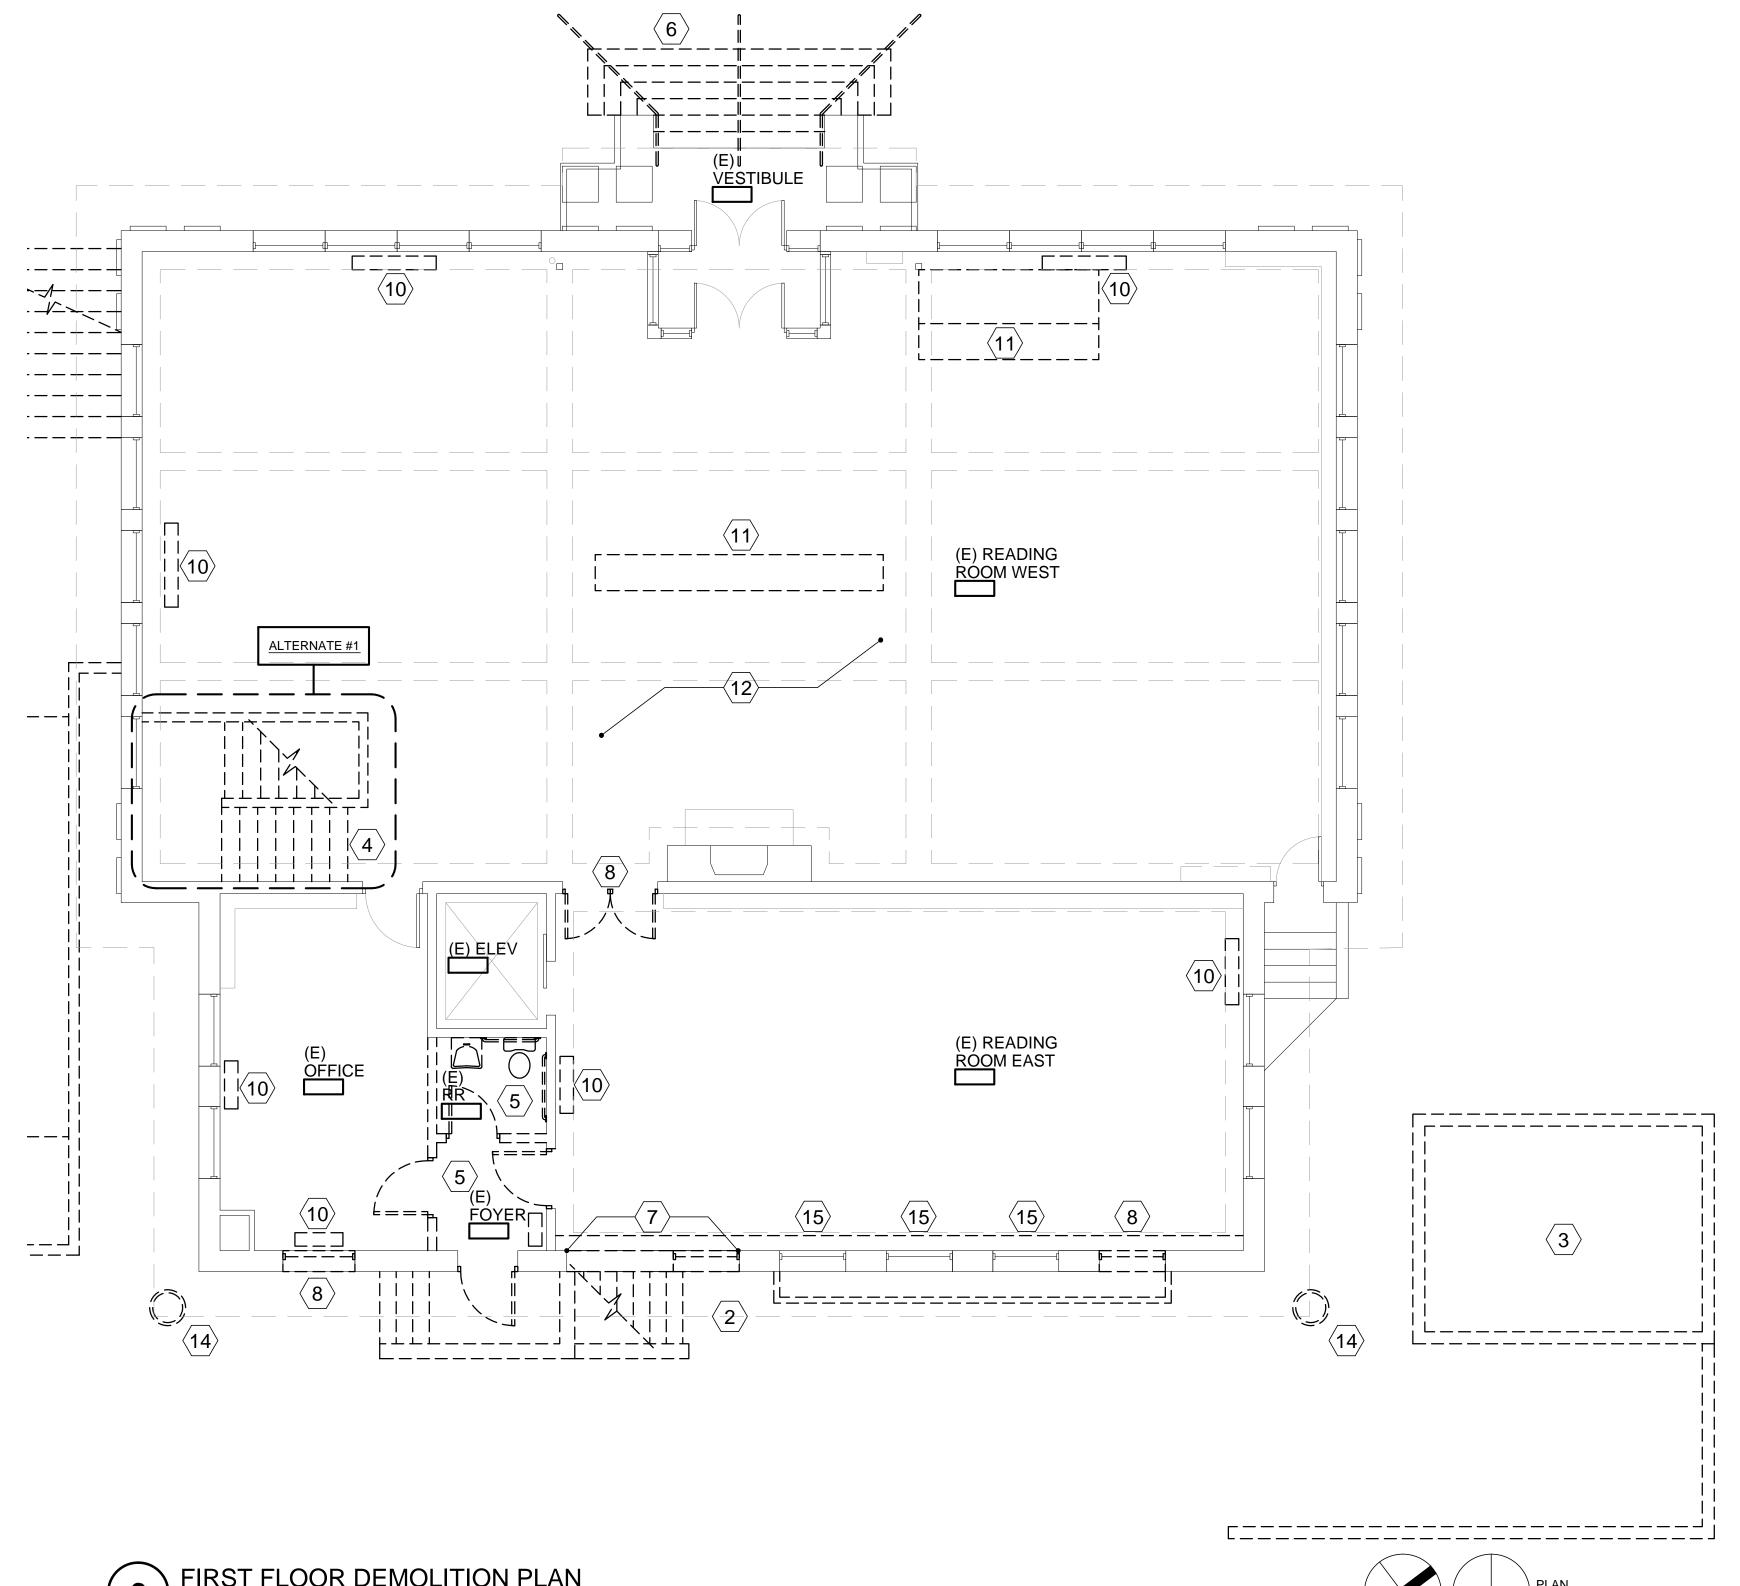

LOWER LEVEL DEMOLITION PLAN

F----1

| -----

L----'

11-----

1 ----

||----


i -----

| | - - - - - - |

I **----**

-==_{₹1}

ALTERNATE #1

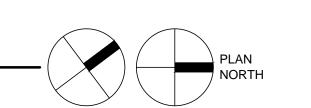

L______

(E) READING

L-----

(E) ELEV MACHINE

L-----

(E) STORAGE

FIRST FLOOR DEMOLITION PLAN


3/16'=1'-0"

GENERAL NOTES		KEYNOTES					
PROTECT ALL BUILDINGS, UTILITIES, VEGETATION ETC TO REMAIN.	SYMBOL	DESCRIPTION	SYMBOL	DESCRIPTION			
2. EXISTING CARNEGIE LIBRARY TO REMAIN OPERATIONAL DURING CONSTRUCTION. PROVIDE	1	REMOVE EXISTING CONCRETE RAMP, STAIR, AWNING, SITE WALLS AND RAILINGS.	\(13\)	REMOVE WINDOW, FRAME AND LIGHT WELL COMPLETE.			
FRONT ACCESS AND ADA RAMP ACCESS UNTIL COMPLETION OF ADDITION. COORDINATE WITH LIBRARY DIRECTOR AND OREGON CITY ACCESS TO AND FROM CARNEGIE.	<u>(2)</u>	REMOVE EXISTING CONCRETE STAIR, WALLS, RAILINGS AND CANOPY.	\(14\)	EXISTING LIGHT FIXTURE TO BE REMOVED AND RELOCATED, SEE SITE PLANS.			
3. COORDINATE ALL FIXTURE, FURNISHING AND EQUIPMENT DEMOLITION WITH LIBRARY DIRECTOR.	3	REMOVE EXISTING TRASH ENCLOSURE AND CONCRETE SITE WALLS, REFERENCE SITE DEMOLITION PLAN.	(15)	EXISTING WINDOWS TO REMAIN, REMOVE BRICK SILL AND WALL BELOW TO FINISH FLOOR.			
. REFER TO PLANS, SECTIONS, ELEVATIONS, CIVIL, LANDSCAPE, STRUCTURAL, MECHANICAL, ELECTRICAL AND PLUMBING DRAWINGS FOR FULL EXTENT OF DEMOLITION TO PLACE NEW	4	ALTERNATE #1: REMOVE EXISTING STAIR TO BASEMENT.	(16)	REMOVE EXISTING PLUMBING FIXTURES COMPLETE.			
WORK.	<u>\(5 \)</u>	REMOVE EXISTING WALLS, DOORS, PLUMBING FIXTURES AND ELECTRICAL COMPLETE.	(17)	REMOVE BOTH TOILETS AND ONE SINK AT EXISTING WOMEN'S RESTROOM AND SINGLE TOILET AND SINK AT EXISTING MEN'S RESTROOM.			
	6	REMOVE EXISTING CONCRETE STAIR AND HANDRAILS.	18	REMOVE EXISTING WALL AND PAIR OF DOORS COMPLETE.			
	<u></u>	REMOVE WINDOW AND PORTION OF EXISTING BRICK WALL, REFERENCE FIRST FLOOR PLAN AND SECTIONS.	(19)	REMOVE PORTION OF EXISTING WALL FOR NEW DOOR, REFERENCE PLAN.			
	8	REMOVE DOOR OR WINDOW AND FRAME.					
	9	REMOVE CARPET.					
	(10)	REMOVE EXISTING RADIATORS.					
	(11)	REMOVE EXISTING BUILT-IN CABINETRY.					
	√12 >	REMOVE LIGHTING AND MECHANICAL SYSTEMS COMPLETE EACH FLOOR.					

SITE PLAN DESIGN REVIEW & HISTORIC DESIGN REVIEW SUBMITTAL PACKAGE

BUILDING DEMOLITION PLAN - CARNEGIE

JANUARY 23, 2015 Drawn By: Checked By: Sheet No:

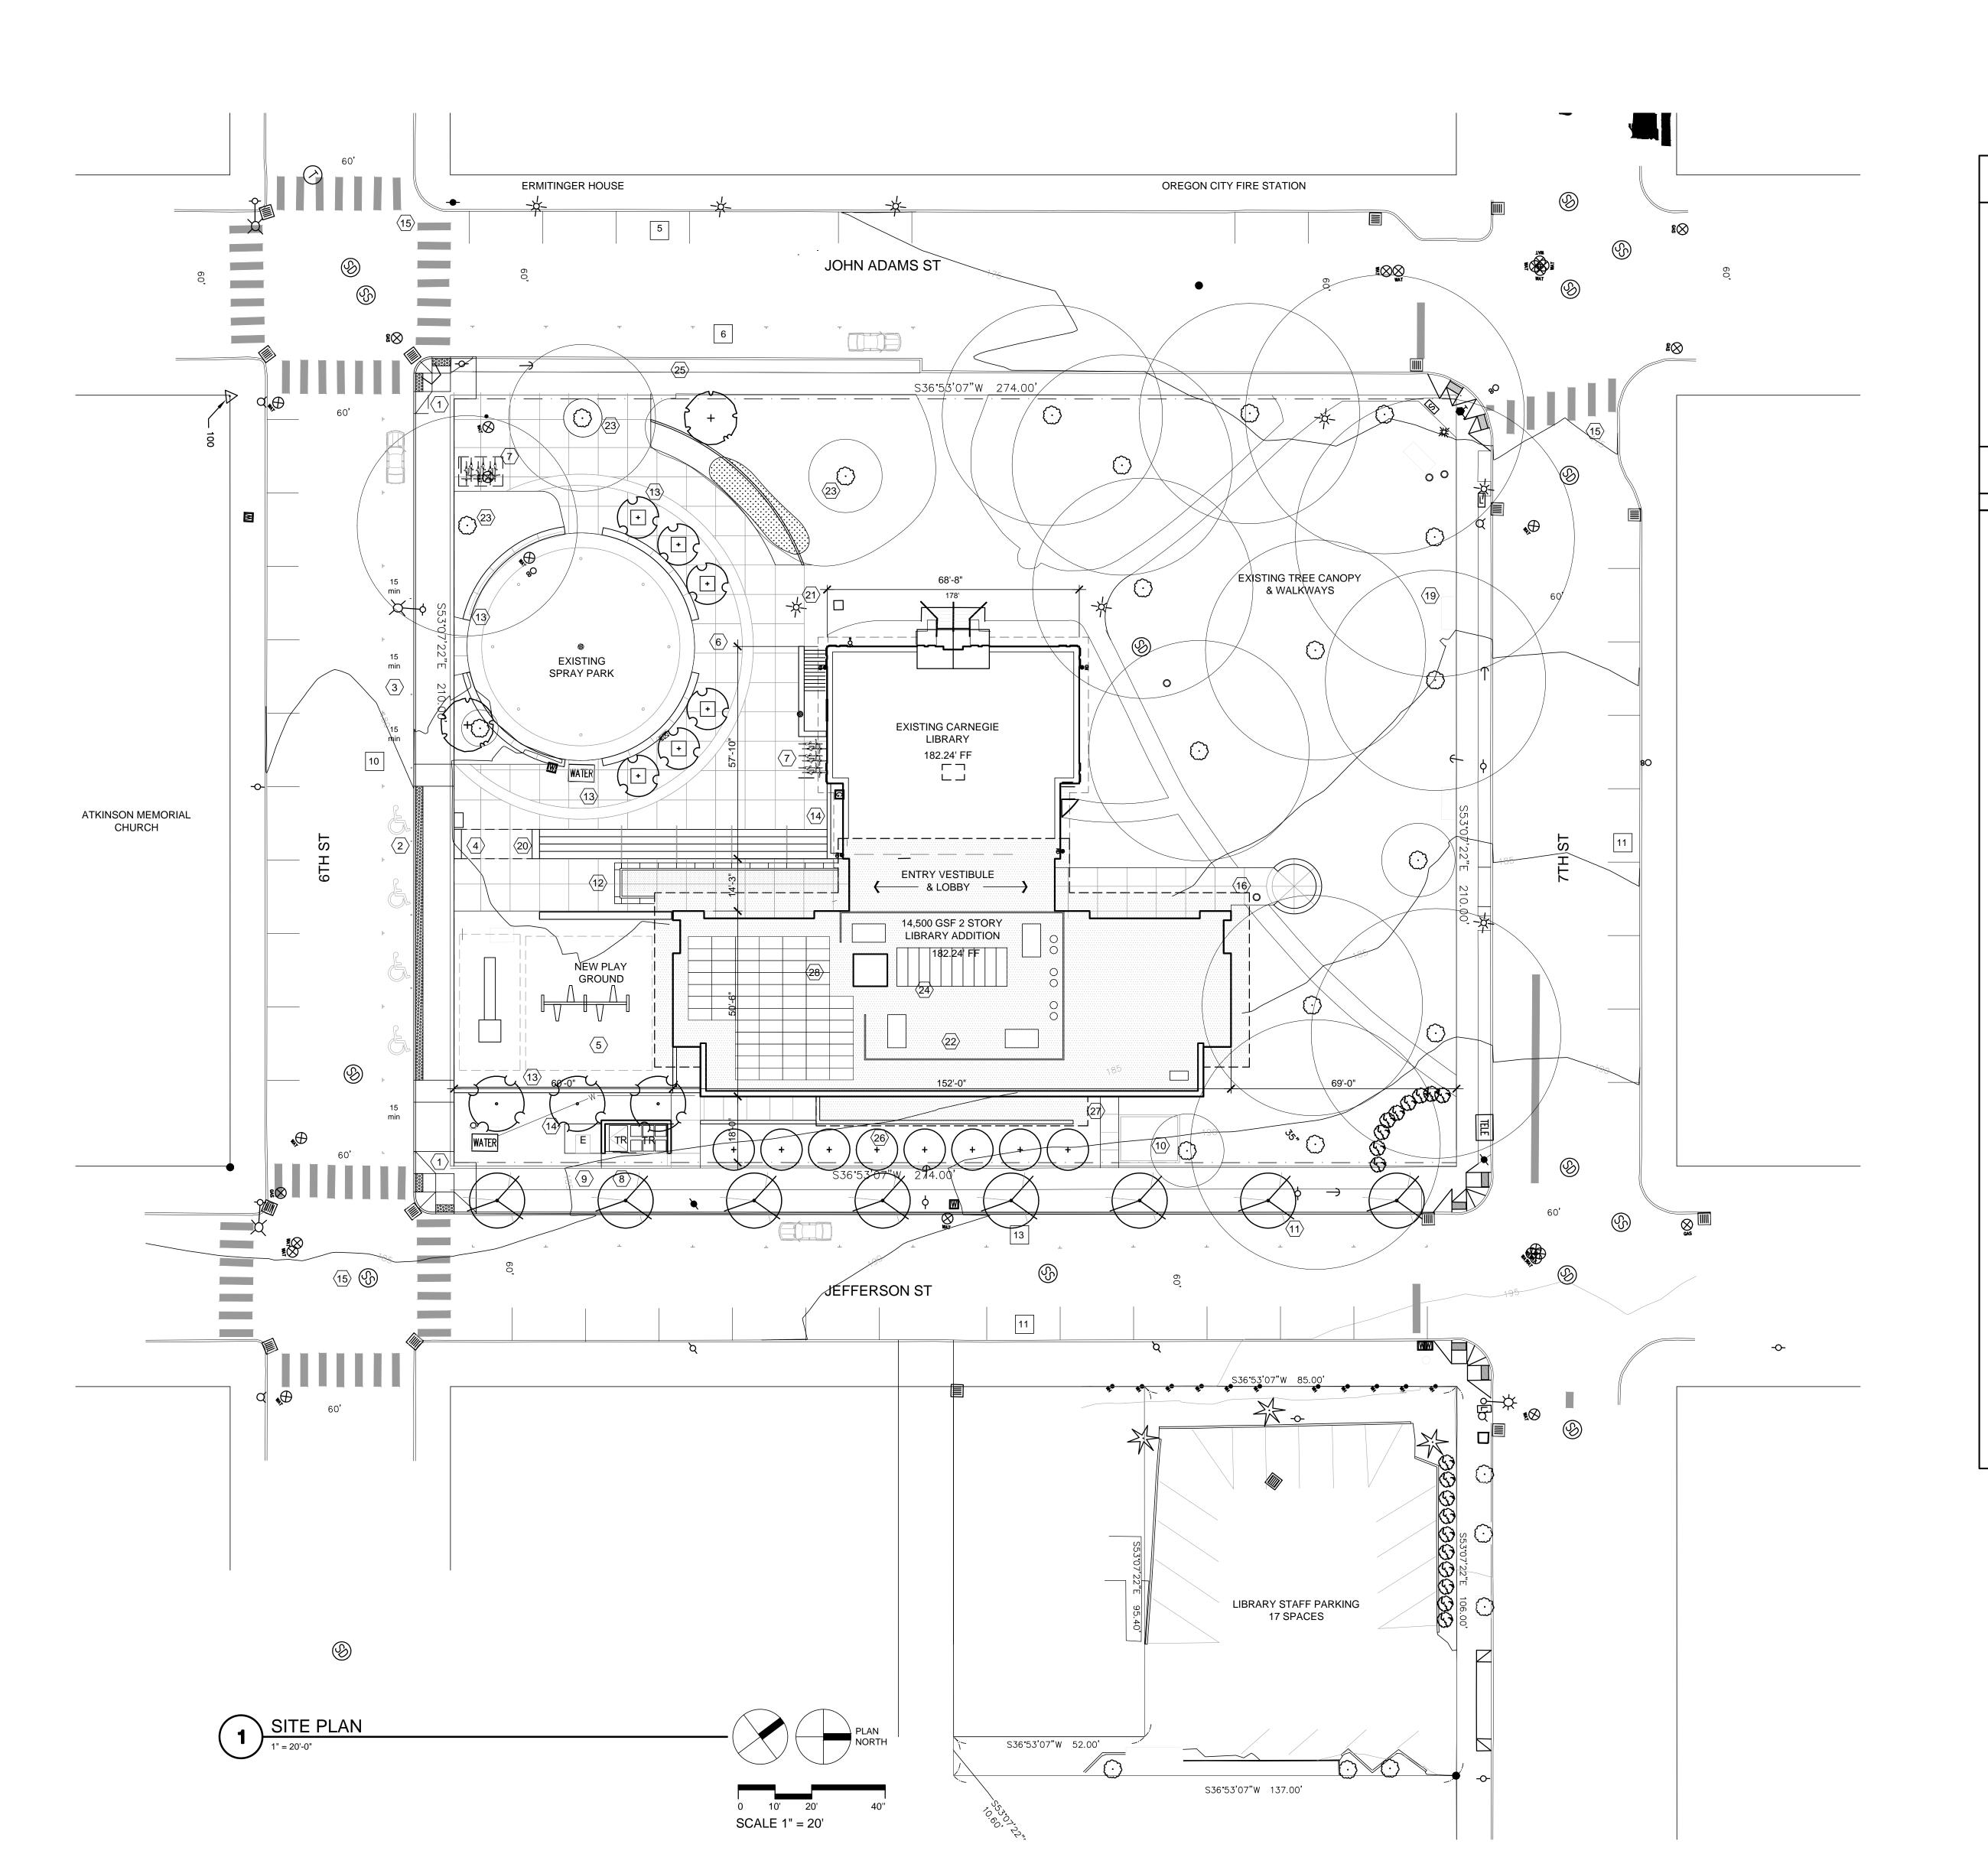

GENERAL NOTES

- PROTECT ALL BUILDINGS, UTILITIES, VEGETATION ETC TO REMAIN, .
- SEE CIVIL DRAWINGS FOR BALANCE OF INFORMATION.
- . MAINTAIN 2% MAX CROSS SLOPE AT ALL NEW CONCRETE WALKWAYS & ACCESSIBLE AISLES.
- 4. DEMO (E) VEGETATION, OBSOLETE POWER POLES, MISC ITEMS AS NECESSARY FOR NEW CONSTRUCTION.
- MOVE (E) UTILITIES & UTILITY MONUMENTS AS NECESSARY FOR NEW CONSTRUCTION.
- 6. INCREASE ROW BY 1' EAST ON JOHN ADAMS AND 1' NORTH ON 6TH ST AS REQUESTED BY OREGON CITY PLANNING DEPARTMENT

KEYNOTES

SYMBOL DESCRIPTION

- NEW SIDEWALK, STREET CURB & CORNER CURB ENTIRE LENGTH OF 6TH
- ADA ACCESSIBLE PARKING SPACES (4) W/ ACCESSIBLE AISLE, CURB RAMP &
- (4) 10 MINUTE DROP OFF SPACES AS RECOMMENDED BY TRAFFIC STUDY
- 4BOOK DROP
- NEW PLAY EQUIP & SOFT SURFACE TO REPLACE EXISTING
- NEW PERVIOUS PAVING (LID), SEAT WALL & PLANTING (4" CALIPER TREES) AT EXISTING SPRAY PARK. EXISTING CONC WALL TO BE REMOVED.
- $\langle 7 \rangle$ BIKE RACK (6) 50% OF BIKE PARKING WILL BE COVERED
- TRASH & RECYCLING ENCLOSURE (WITH GREEN ROOF ADD ALTERNATE)
- (9) TRANSFORMER & PAD
- STORM WATER PLANTING
- NEW STREET TREES ALONG JEFFERSON
- ENTRY CANOPY (WITH GREEN ROOF ADD ALTERNATE)
- NEW SEAT WALL & PLANTING
- (14) LANDSCAPE PLANTING
- EXISTING STRIPING FOR PEDESTRIAN CROSSING
- \(\sqrt{16}\) NEW WALKWAY, CONNECT TO EXISTING
- EXISTING SIDEWALK & CURB TO REMAIN (ALLOW 30% REPLACEMENT DUE TO
- \$\langle 18 STRIPE & SIGN PARKING FOR 2 HOUR LIMIT
- EXISTING BENCHES TO REMAIN
- 20 PLAZA SIGNAGE
- EXISTING SITE LIGHTING TO REMAIN & 2 TO BE RELOCATED.
- MECHANICAL W/ SCREEN
- EXISTING TREE W/ NEW LANDSCAPE
- SKYLIGHT (ADD ALTERNATE)
- NEW CONC SIDEWALK @ EXISTING PLANTING STRIP ALONG JOHN ADAMS
- 26 LINE OF BUILDING SHOWN DASHED BELOW
- SECOND FLOOR EGRESS STAIR EXIT
- PHOTO VOLTAIC ARRAY (1.5% OF CONST COST REQ;D BY ENERGY CODE)
- # PARKING COUNT

OREGON CITY PUBLIC LIBRARY RENOVATION & ADDITION

OREGON CITY, OREGON

SITE PLAN DESIGN REVIEW &
HISTORIC DESIGN REVIEW
SUBMITTAL PACKAGE

Drawing:
SITE PLAN


Ioh No:

Sheet No:

Job No: 1415

Date: JANUARY 23, 2015

Drawn By:
Checked By: -

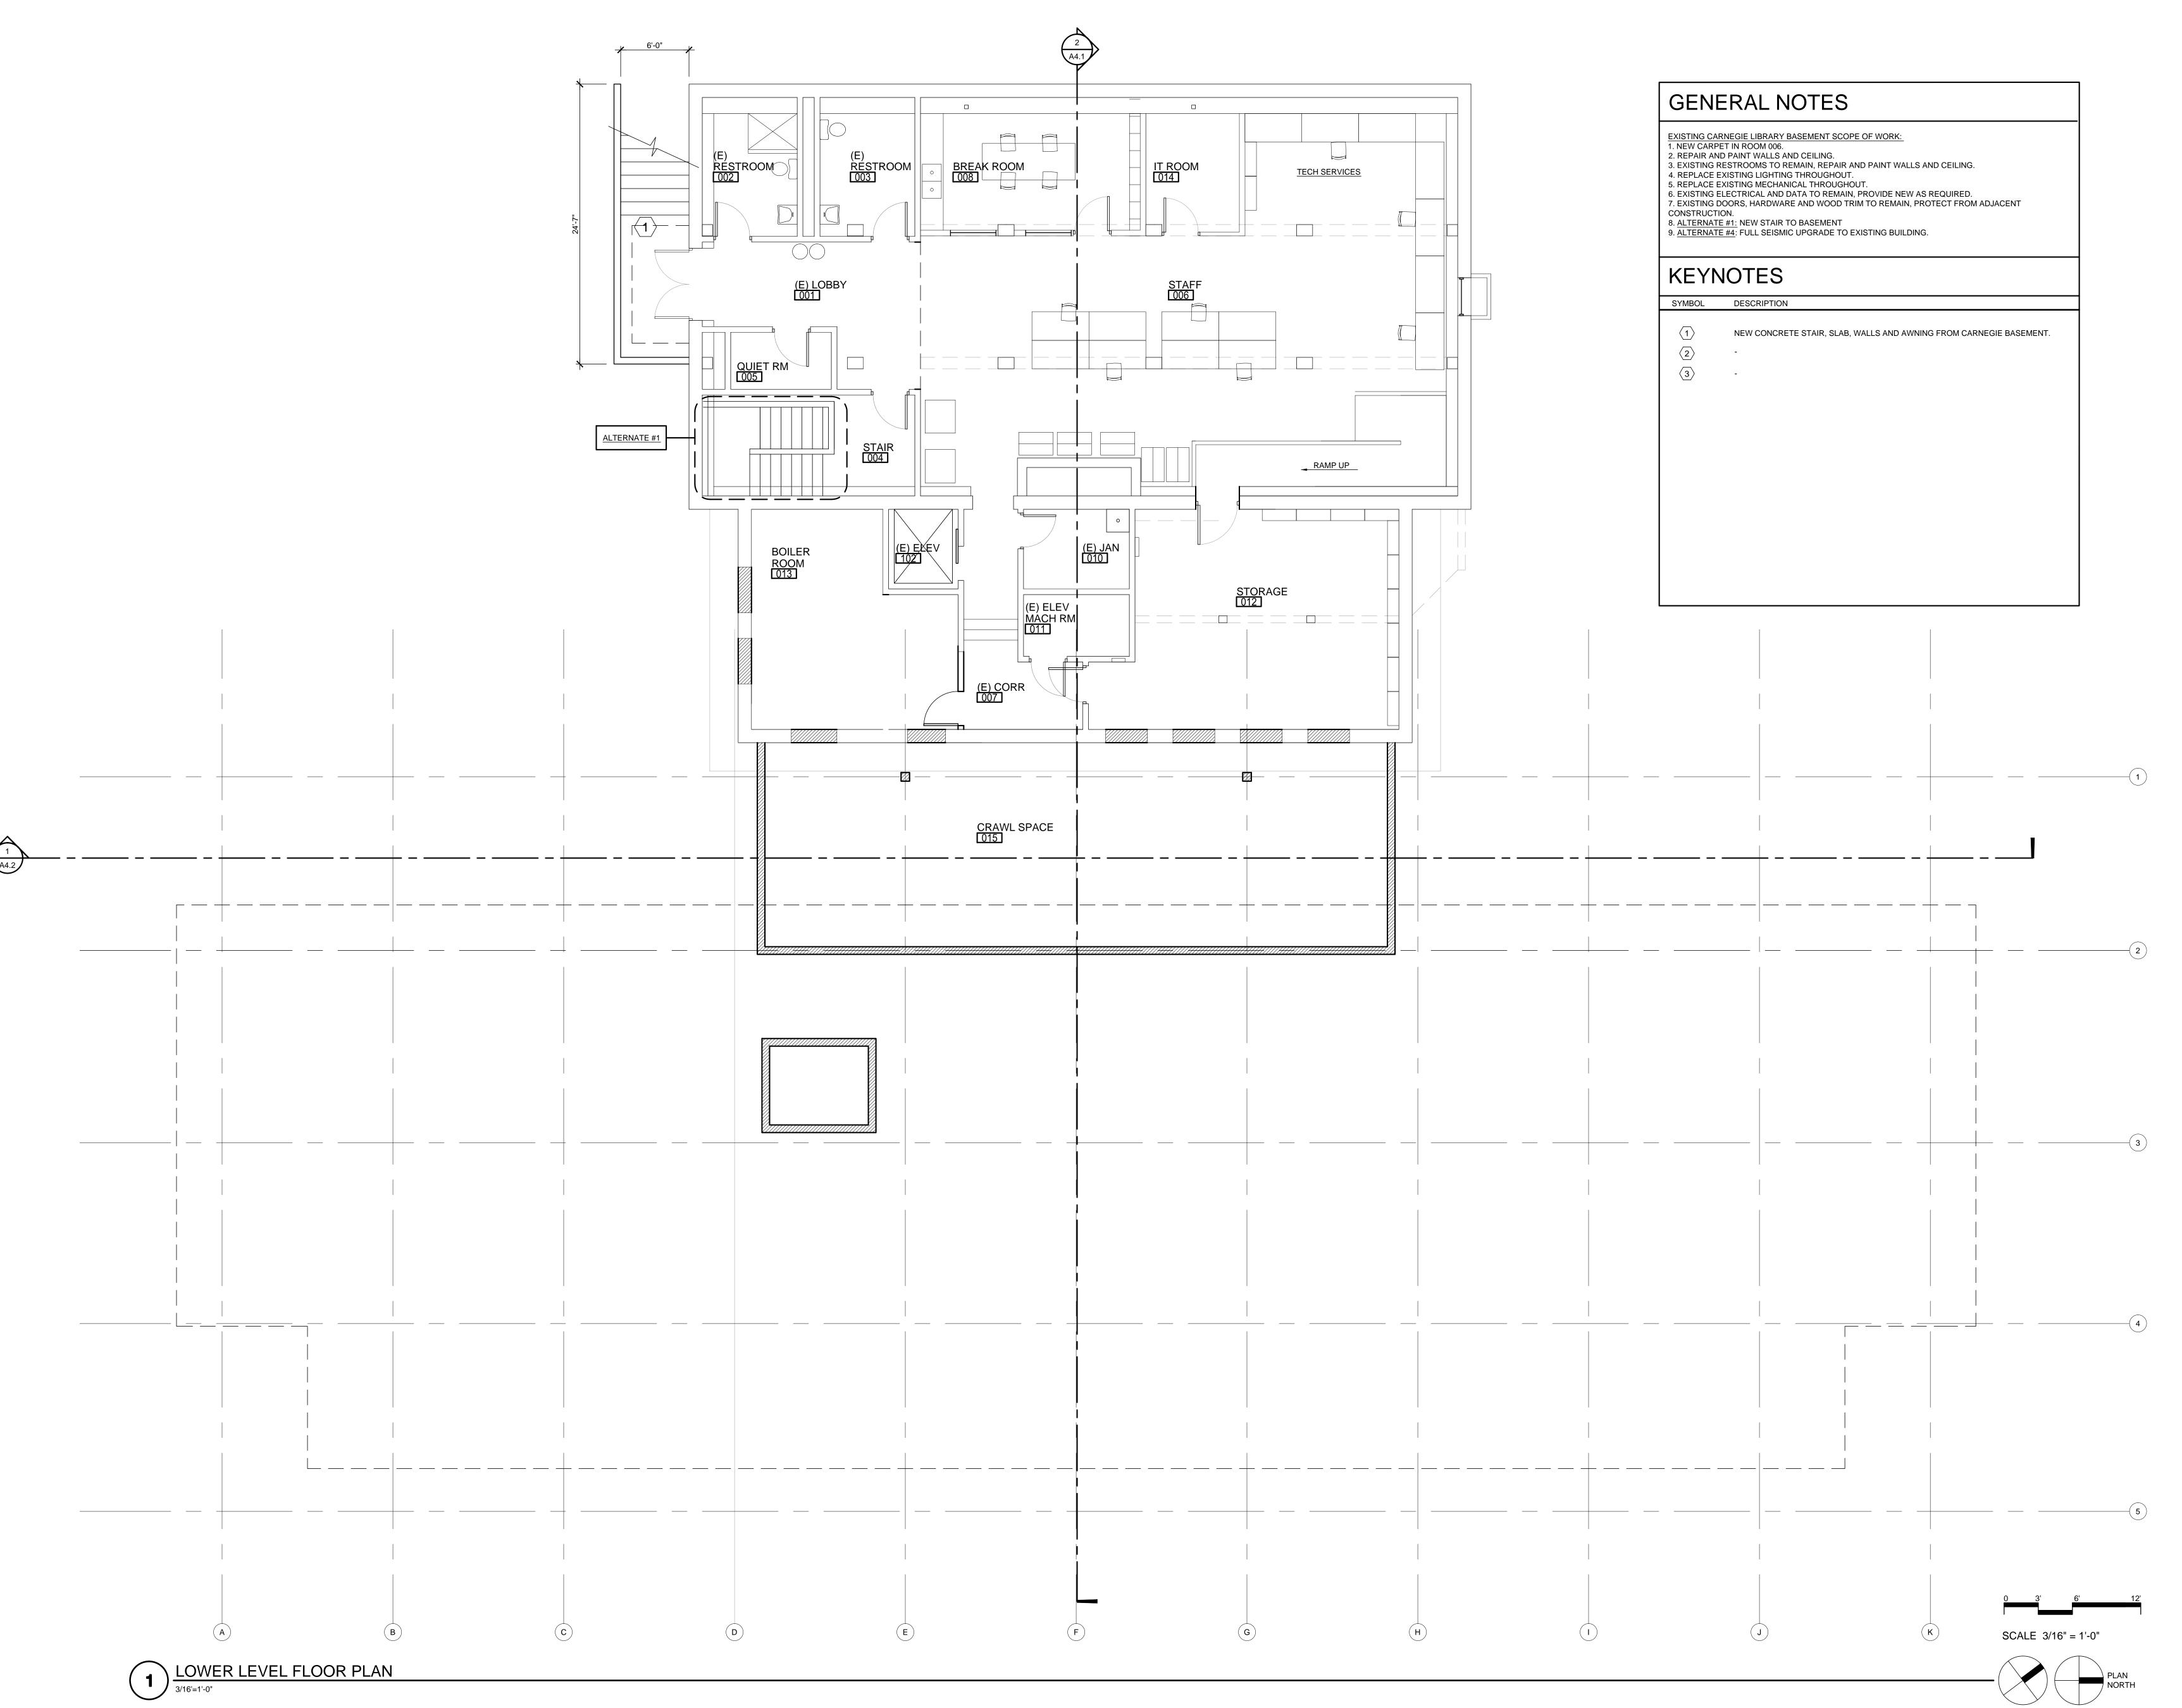

SCOTT EDWARDS ARCHITECTURE LLP.

2525 E. Burnside St., Portland, OR 97214
phone:(503) 226-3617 www.seallp.com

OREGON CITY
PUBLIC LIBRARY
RENOVATION &
ADDITION

OREGON CITY, OREGON

SITE PLAN DESIGN REVIEW &
HISTORIC DESIGN REVIEW
SUBMITTAL PACKAGE

Drawing:


LOWER LEVEL PLAN

Job No:

Date: JANUARY 23, 2015

Drawn By:
Checked By: -

Checked By:
Sheet No:

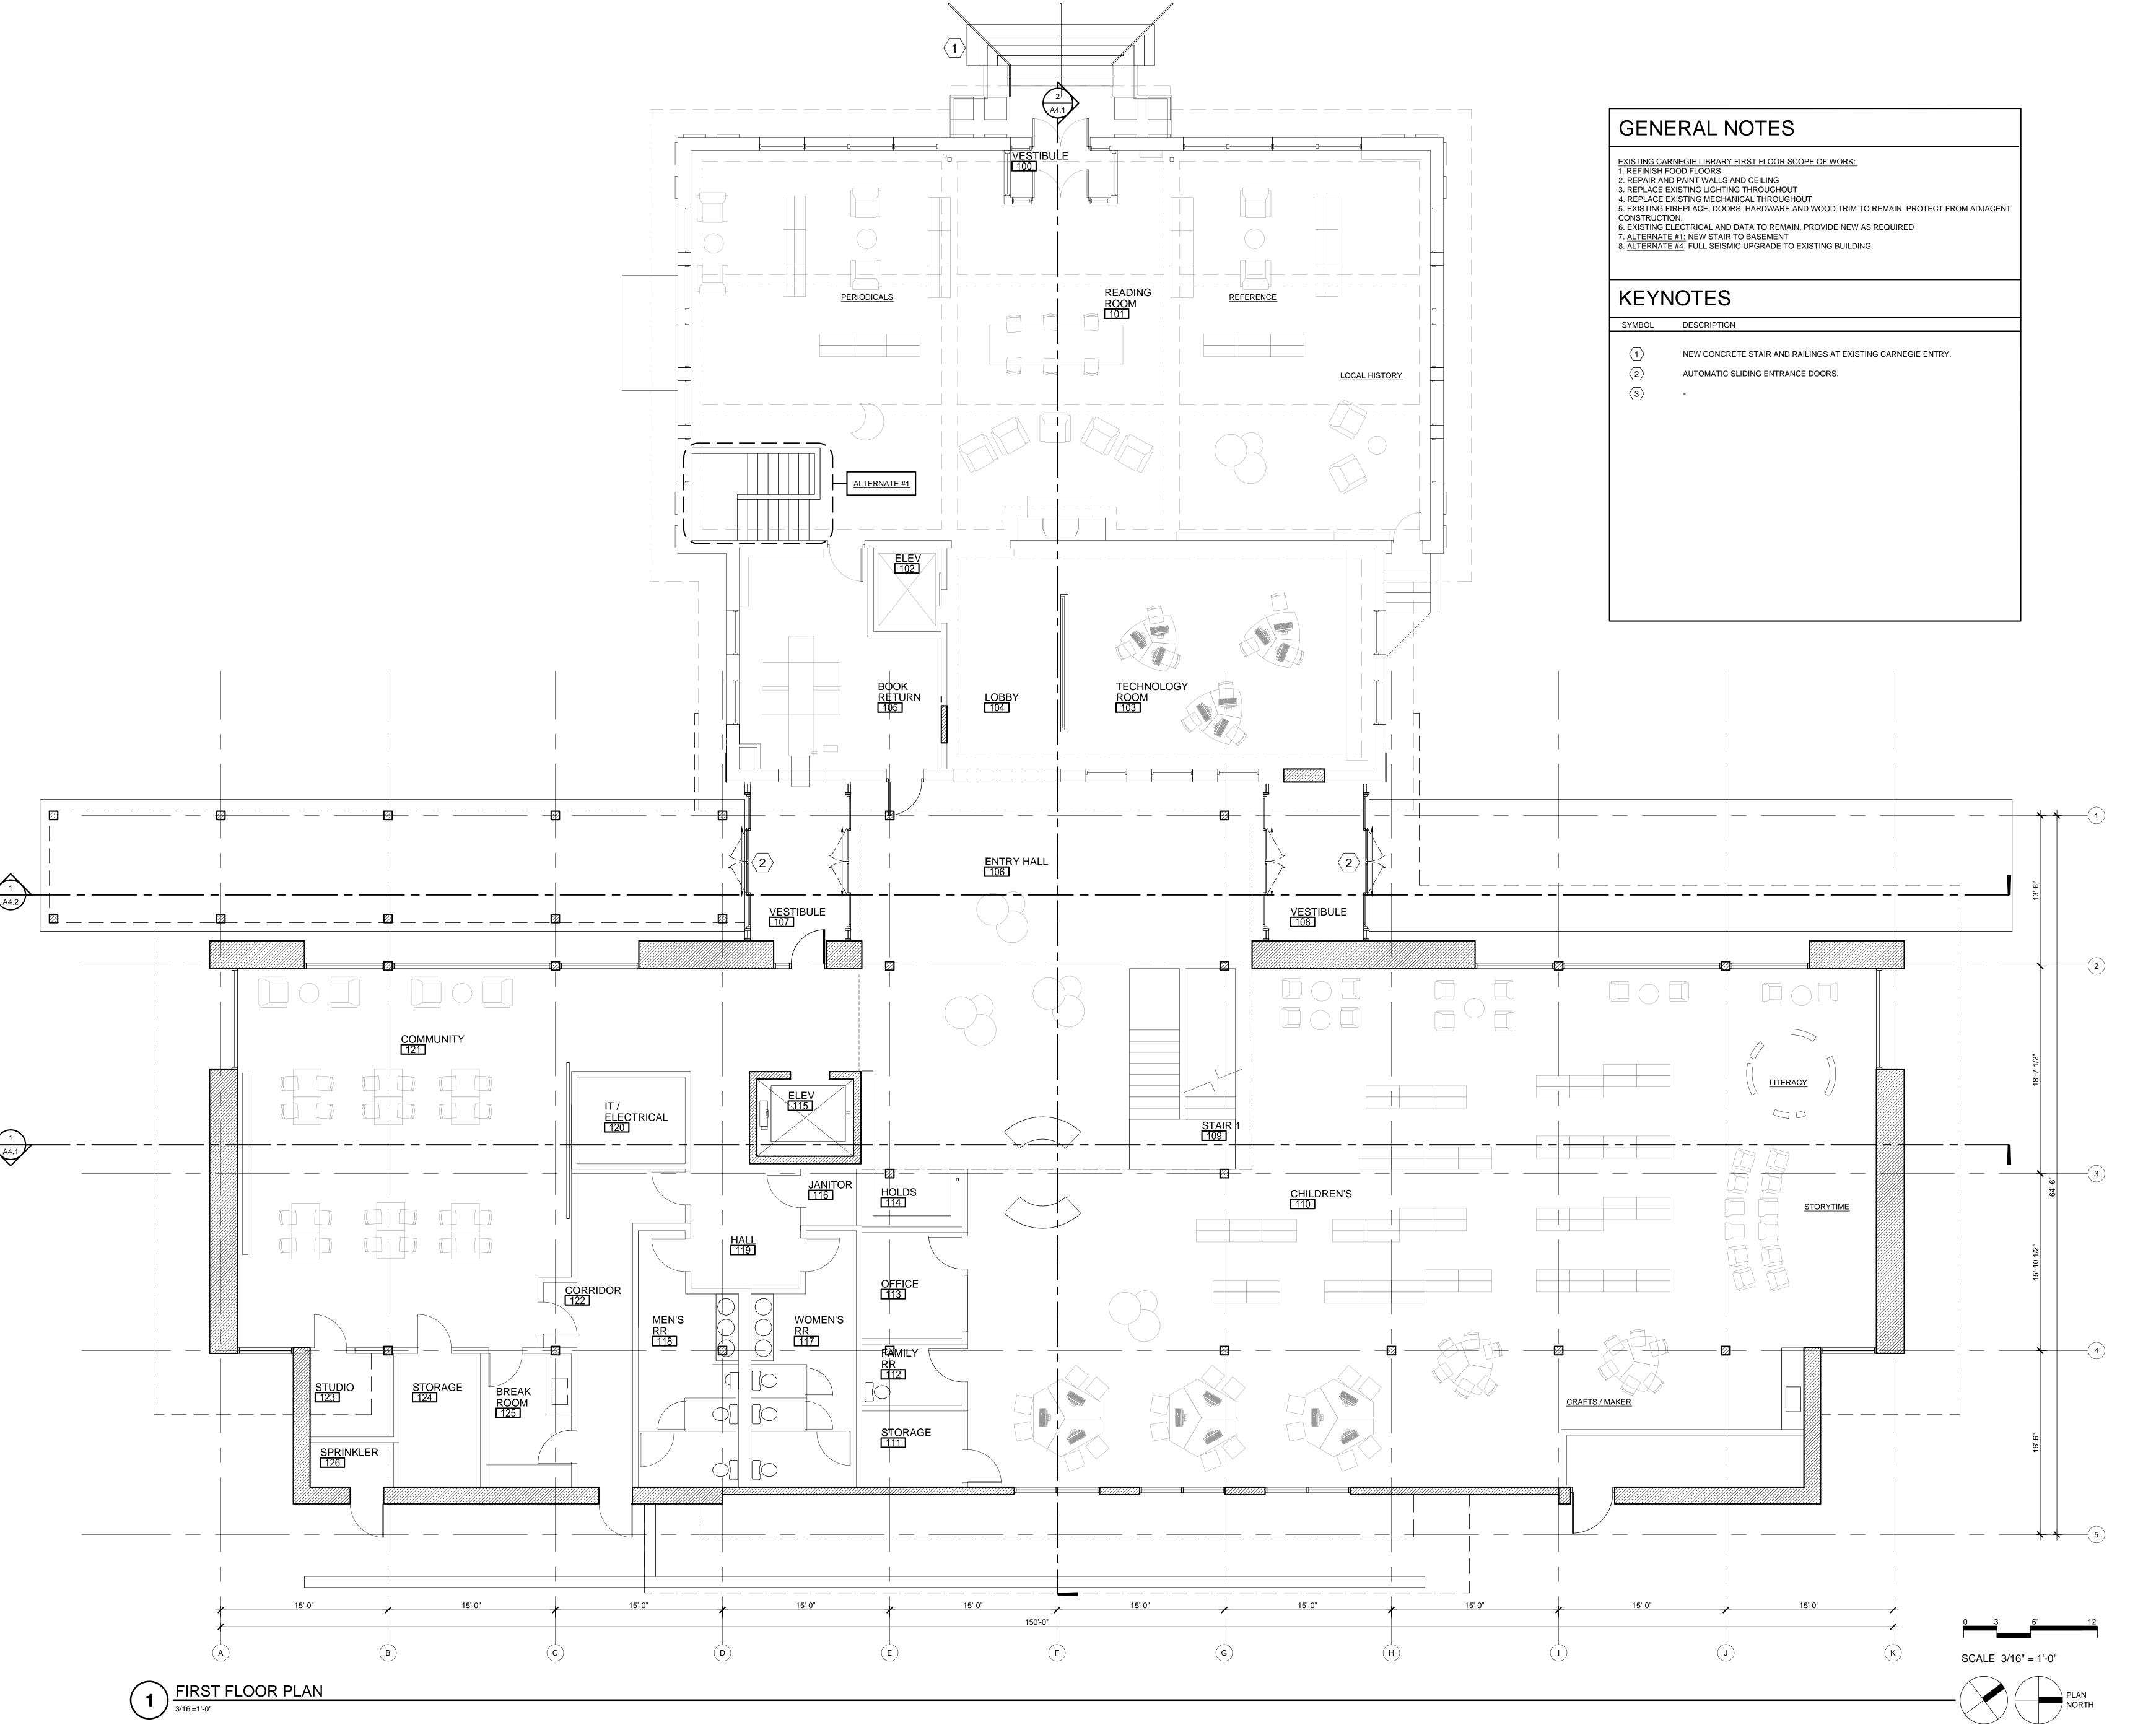

SCOTT EDWARDS ARCHITECTURE LLP.
2525 E. Burnside St., Portland, OR 97214

phone:(503) 226-3617 www.seallp.com

OREGON CITY
PUBLIC LIBRARY
RENOVATION &
ADDITION

OREGON CITY, OREGON

SITE PLAN DESIGN REVIEW &
HISTORIC DESIGN REVIEW
SUBMITTAL PACKAGE

Drawing:
FIRST FLOOR PLAN


Job No: 1415

Date: JANUARY 23, 2015

Drawn By:
Checked By: -

Sheet No:

A2.1

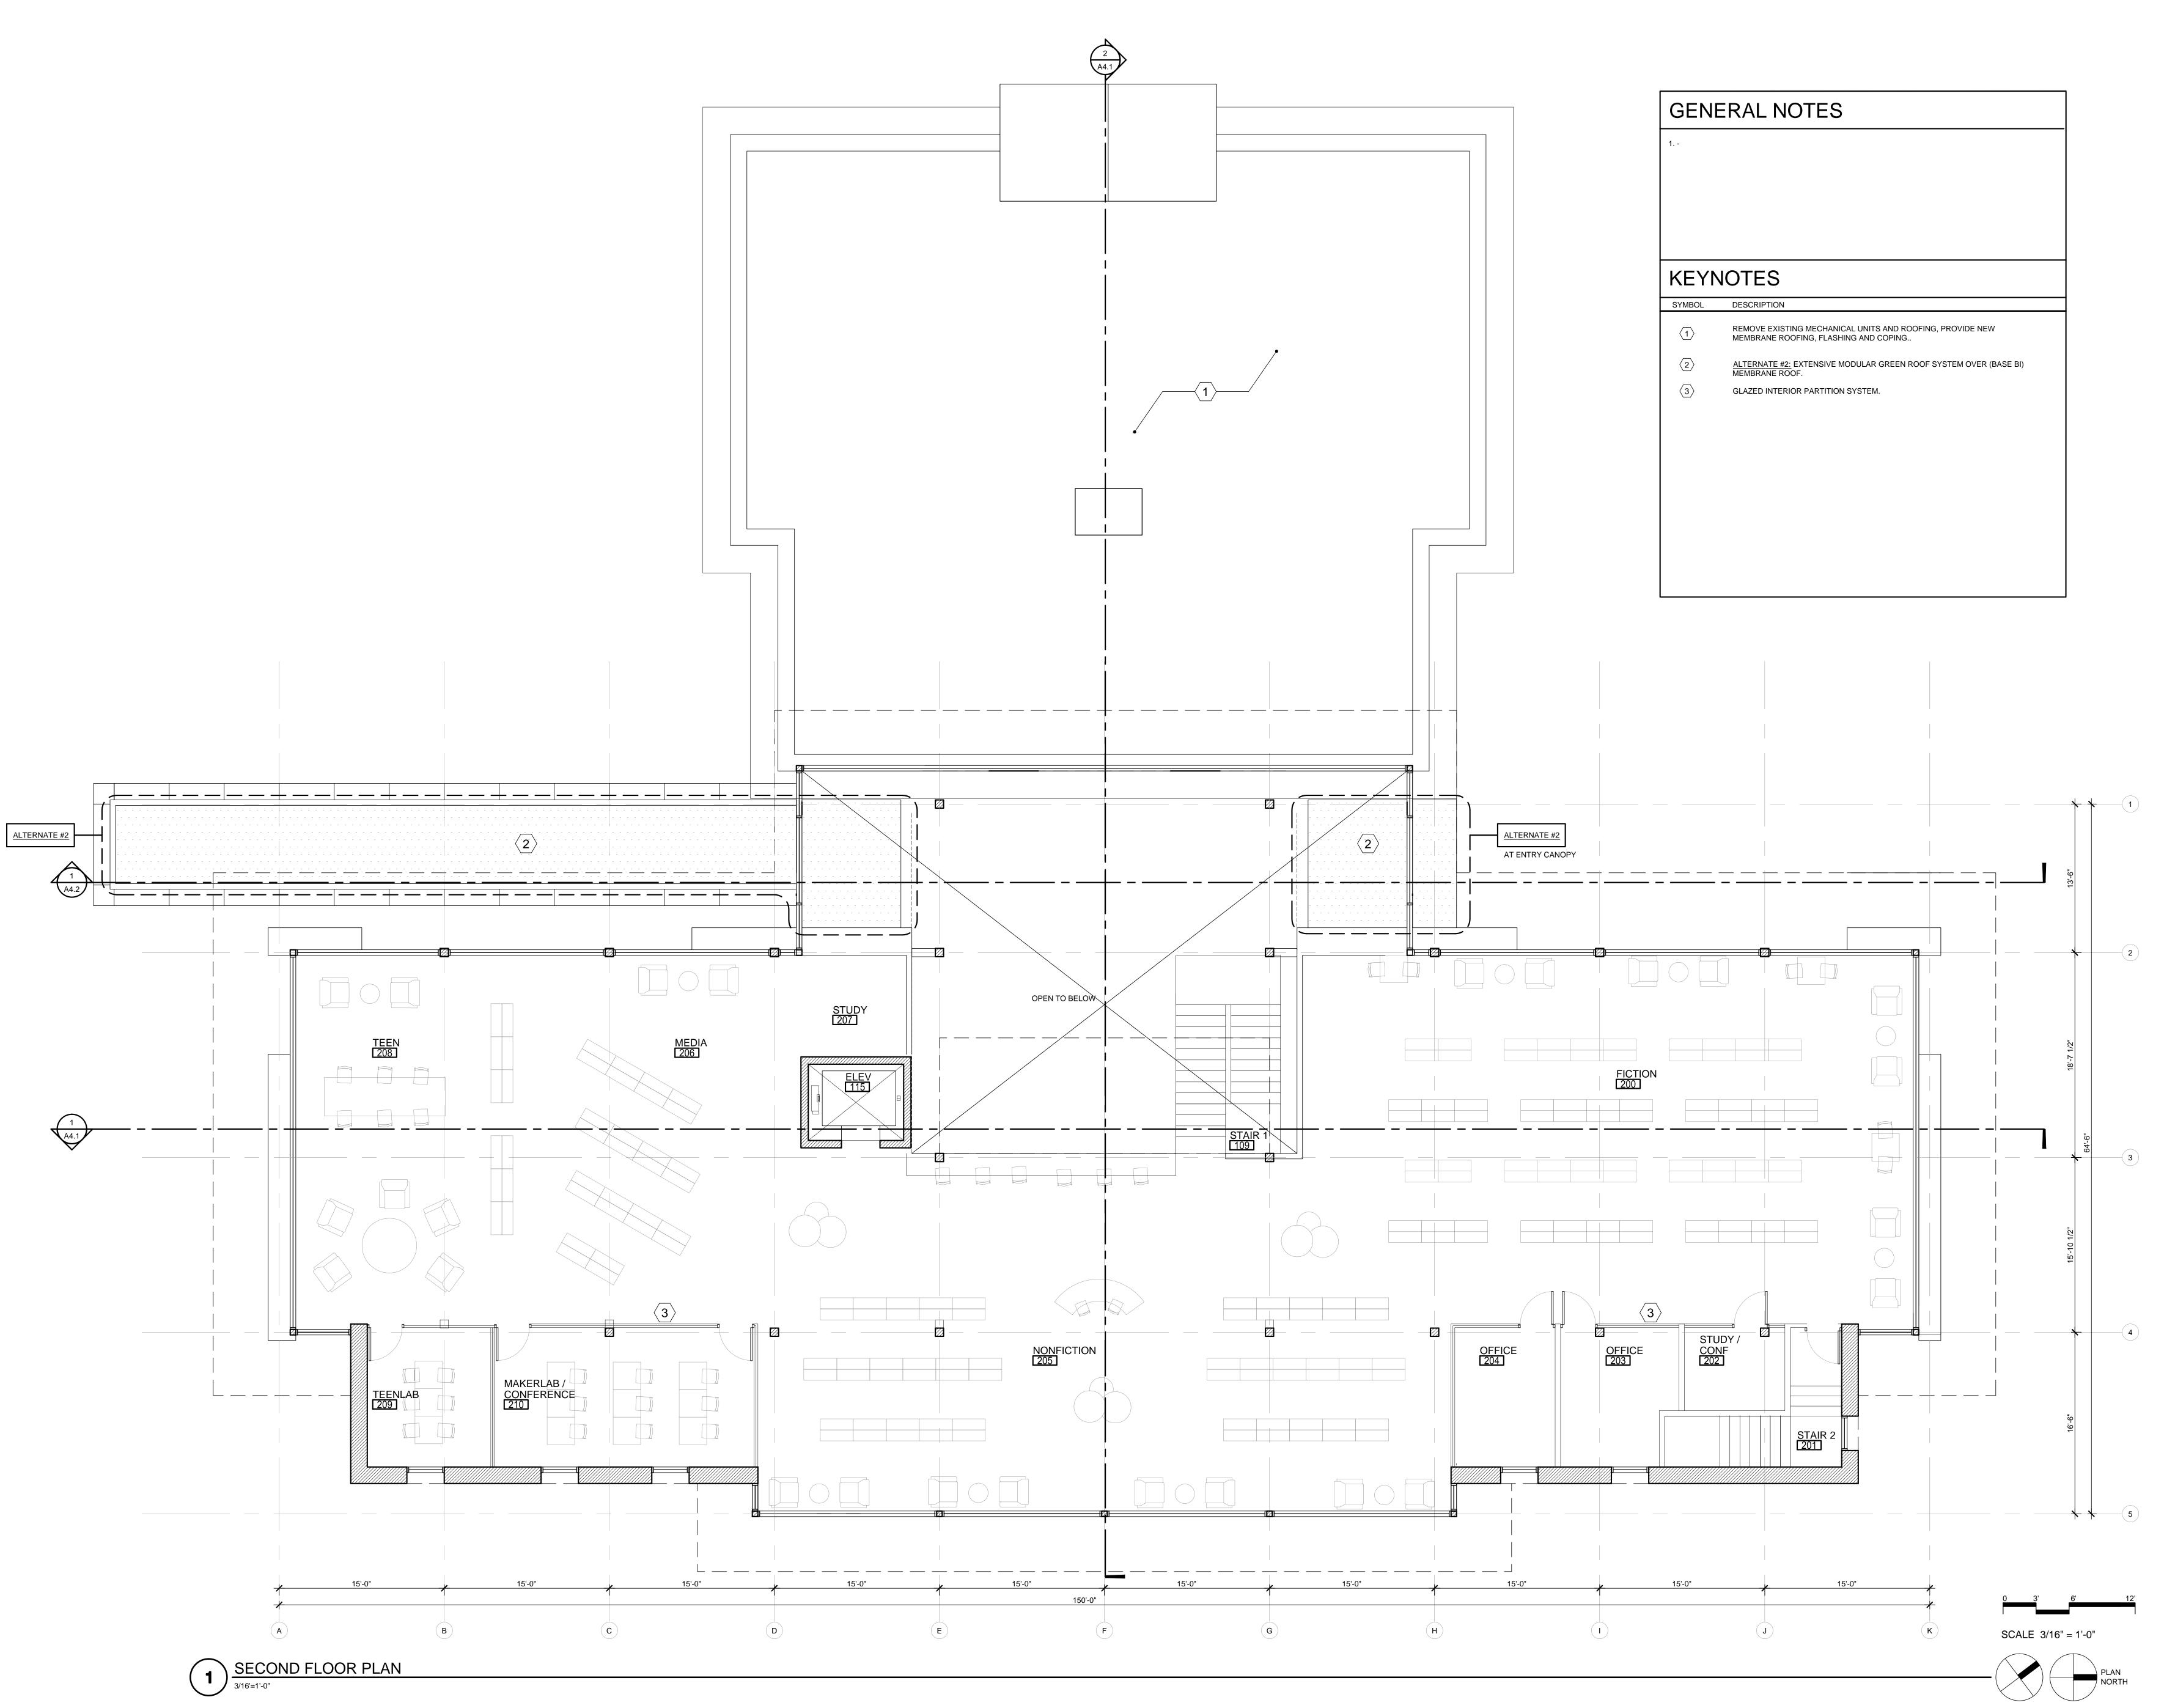

SCOTT EDWARDS ARCHITECTURE LLP.

2525 E. Burnside St., Portland, OR 97214
phone:(503) 226-3617 www.seallp.com

OREGON CITY
PUBLIC LIBRARY
RENOVATION &
ADDITION

OREGON CITY, OREGON


SITE PLAN DESIGN REVIEW &
HISTORIC DESIGN REVIEW
SUBMITTAL PACKAGE

Drawing:
SECOND FLOOR PLAN

Job No: 1415

Date: JANUARY 23, 2015

Drawn By: Checked By: Sheet No:

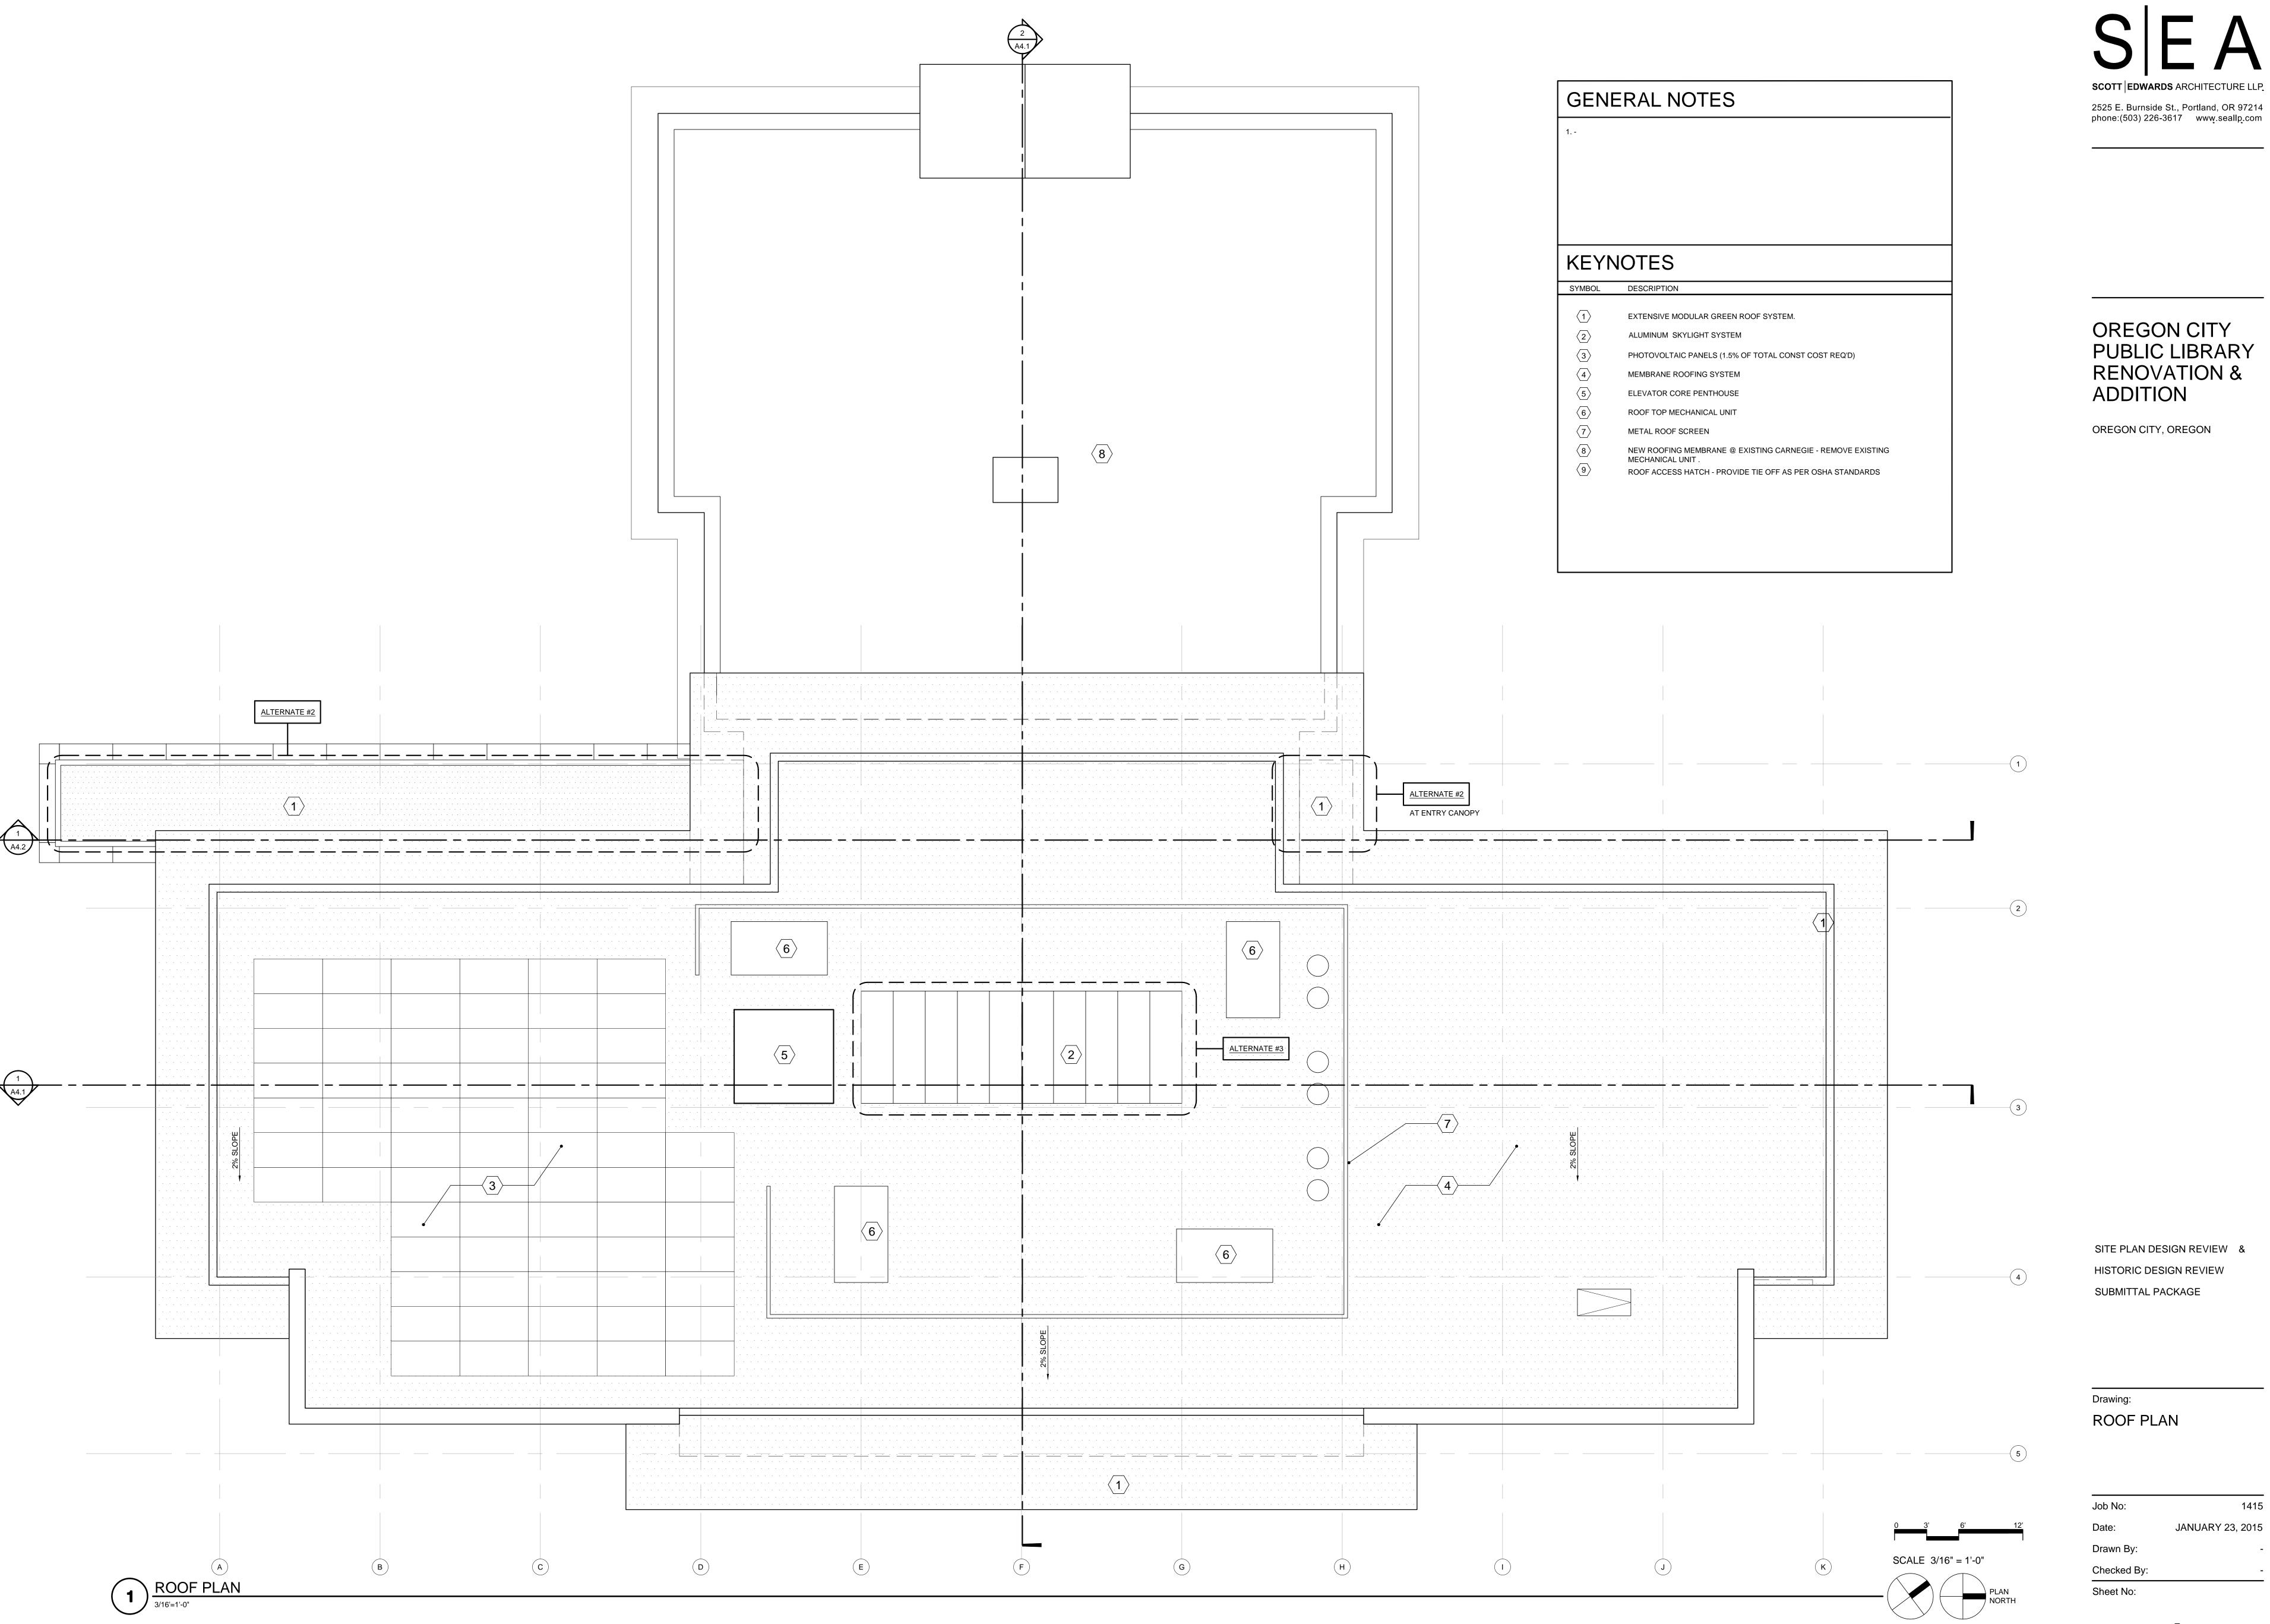

A2.3



LIBRARY

ALTERNATE #2

0'-0" (182.24' ASL) FIN FL

SOUTH ELEVATION

3/16'=1'-0"

2525 E. Burnside St., Portland, OR 97214 phone:(503) 226-3617 www.seallp.com

> OREGON CITY PUBLIC LIBRARY **RENOVATION & ADDITION**

OREGON CITY, OREGON

GENERAL NOTES

5. REPAIR GUTTERS AND DOWNSPOUTS.

- THE EXISTING CARNEGIE LIBRARY IS LISTED ON THE NATIONAL REGISTER OF HISTORIC PLACES. THE STYLE OF ARCHITECTURE IS LISTED AS AMERICAN RENAISSANCE STYLE. THE STRUCTURE IS A (1) STORY ABOVE GRADE WITH A BASEMENT LEVEL BELOW. EXTERIOR IS A RED BRICK WITH A CREAM ACCENT BRICK. WOOD WINDOWS AND TRIM ARE PAINTED CREAM. NO ALTERATIONS TO THE EXTERIOR OTHER THAN THE EAST (BACK) WALL ARE PROPOSED.
- THE NEW ADDITION IS A (2) STORY ADDITION. THE LOWER EXTERIOR WALLS ARE MASONRY TO ECHO THE CARNEGIE. THEY CONTINUE UP TO THE SAME HEIGHT AS THE TOP OF THE CARNEGIE PARAPET. THE SECOND LEVEL IS PRIMARILY A GLAZED STOREFRONT. THE INTENT OF THE GLAZING IS TO CAPTURE THE PARK VIEWS AS WELL AS DECREASE THE OVERALL MASS OF THE
- EXISTING CARNEGIE LIBRARY EXTERIOR SCOPE OF WORK: 1. TUCK-POINT EXISTING BRICK MORTAR JOINTS AS REQUIRED.
- 2. CLEAN AND SEAL EXISTING BRICK. 3. SCRAPE, PRIME, PATCH AND PAINT EXISTING WINDOWS AND WOOD ENTABLATURE. REPLACE ALL WEATHERSTRIPPING AND SEALANT AS NEEDED.
 4. RE-LAMP EXISTING EXTERIOR LIGHT FIXTURES WITH LED LAMPS.

ANODIZED ALUM WINDOW WALL WITH LOW - E TINTED GLASS WITH

KEYNOTES

SYMBOL DESCRIPTION

EXISTING CARNEGIE, SEE GENERAL NOTES. BRICK VENEER, MUTUAL MATERIALS RUBY RED, TYP.

- RAISED QUOIN TREATMENT AT BRICK VENEER.
- PRECAST COPING
- OPERABLE WINDOWS. OPAQUE SPANDREL GLASS
- ANODIZED ZINC ROOF OVERHANG AND COPING
- PAINTED METAL ENTRY CANOPY WITH GREEN ROOF
- NEW CONCRETE SEAT WALL AT SPAY PARK
- EXTERIOR EGRESS
- NEW STAIRS & RAILING AT EXISTING ENTRY TO IMPROVE SAFETY AND ACCESSIBILITY. RAILING FINISH TO BE OIL RUBBED BRONZE. MTL SIDING TO MATCH ROOF OVERHANG
- NOT USED
- PHOTOVOLTAIC PANELS
- METAL ROOF SCREEN TO MATCH MTL SIDING AND ROOF OVERHANG.
- AUTOMATIC SLIDING ENTRANCE DOORS.

HISTORIC DESIGN REVIEW SUBMITTAL PACKAGE

SITE PLAN DESIGN REVIEW &


EXTERIOR ELEVATIONS


Checked By: Sheet No:





OREGON CITY, OREGON

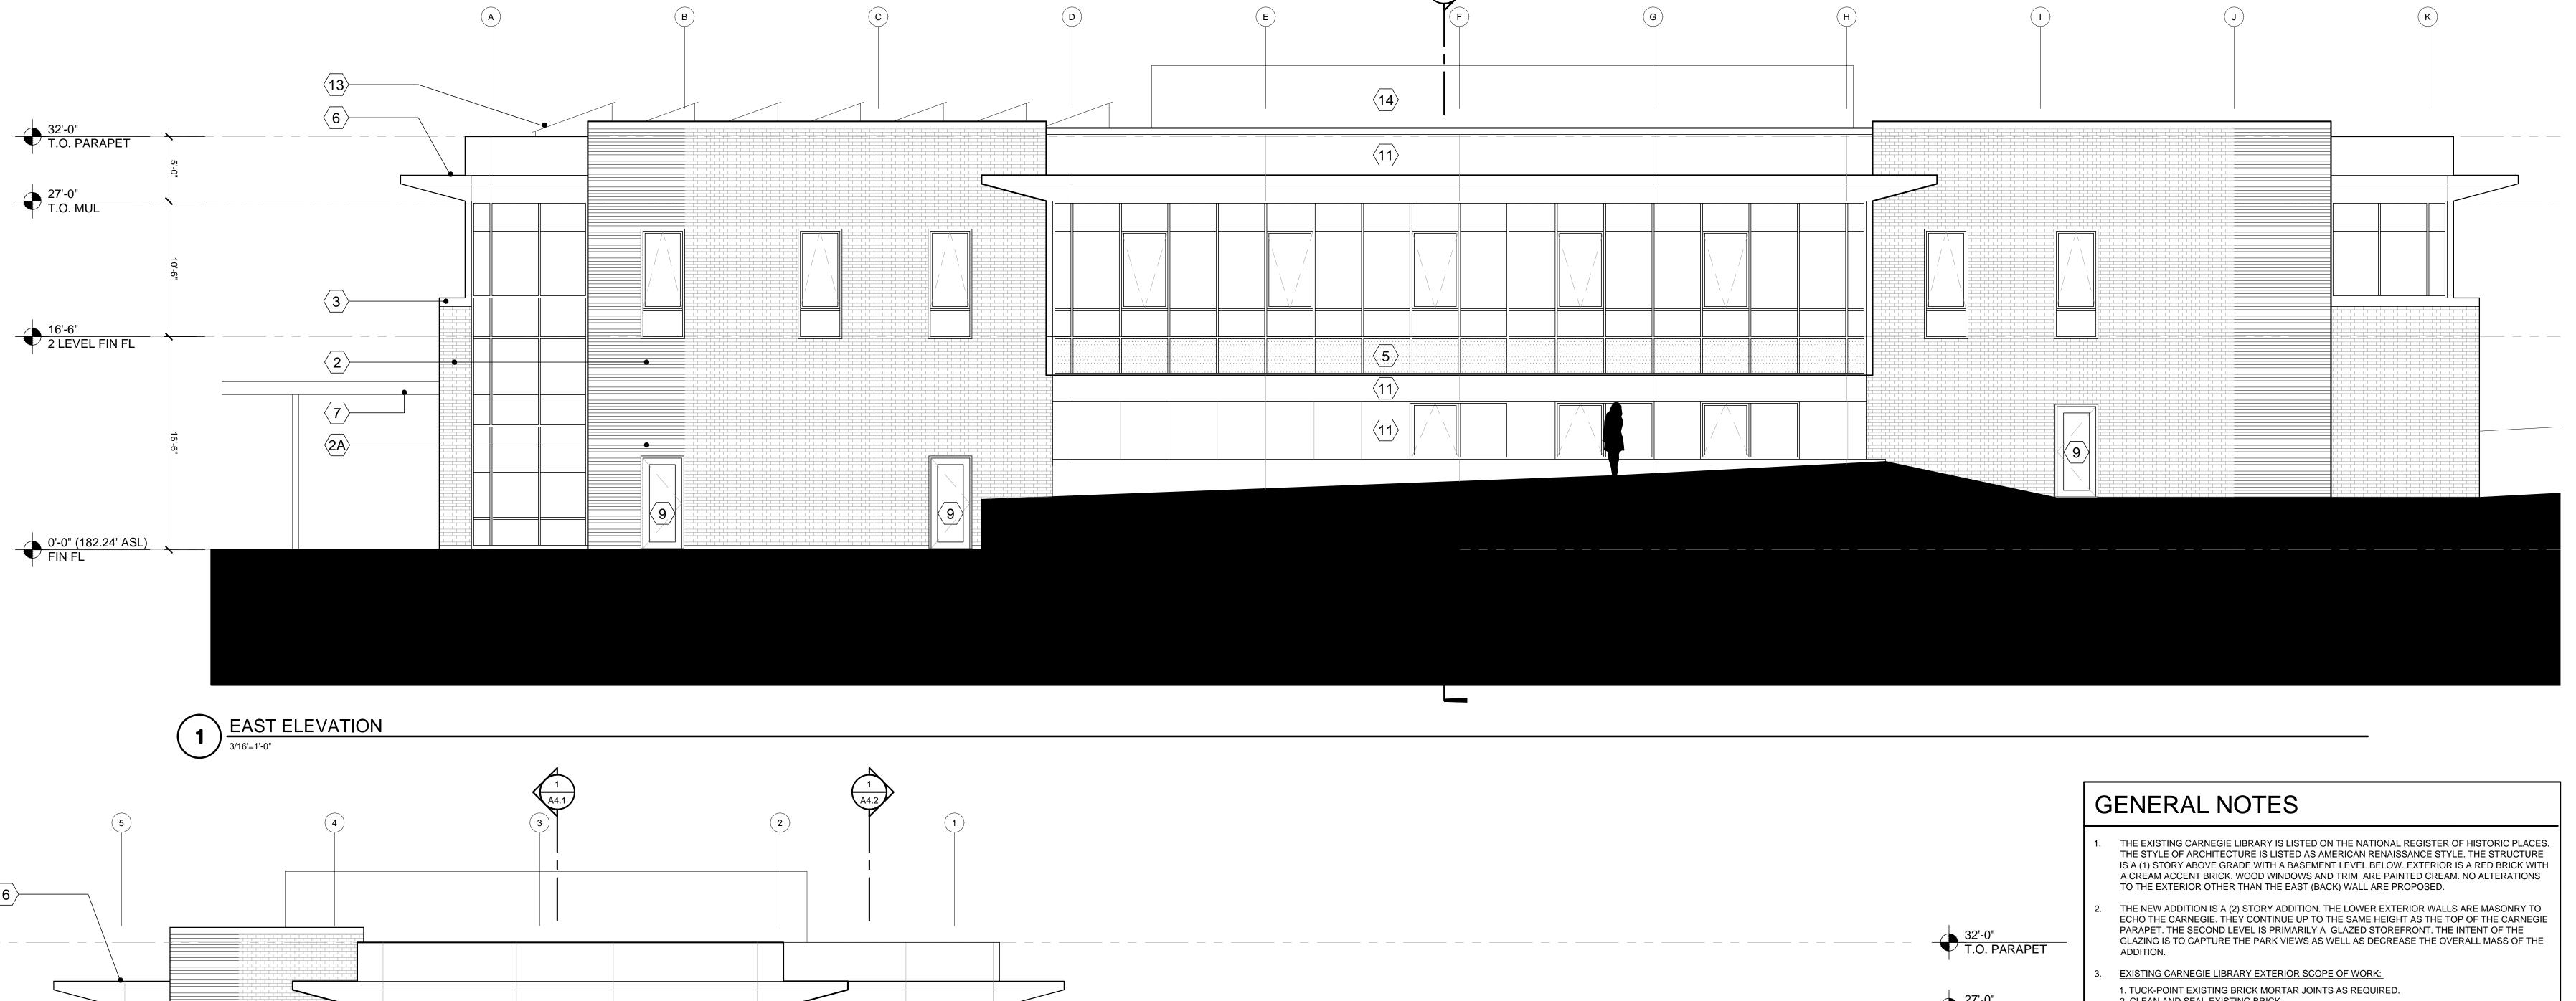

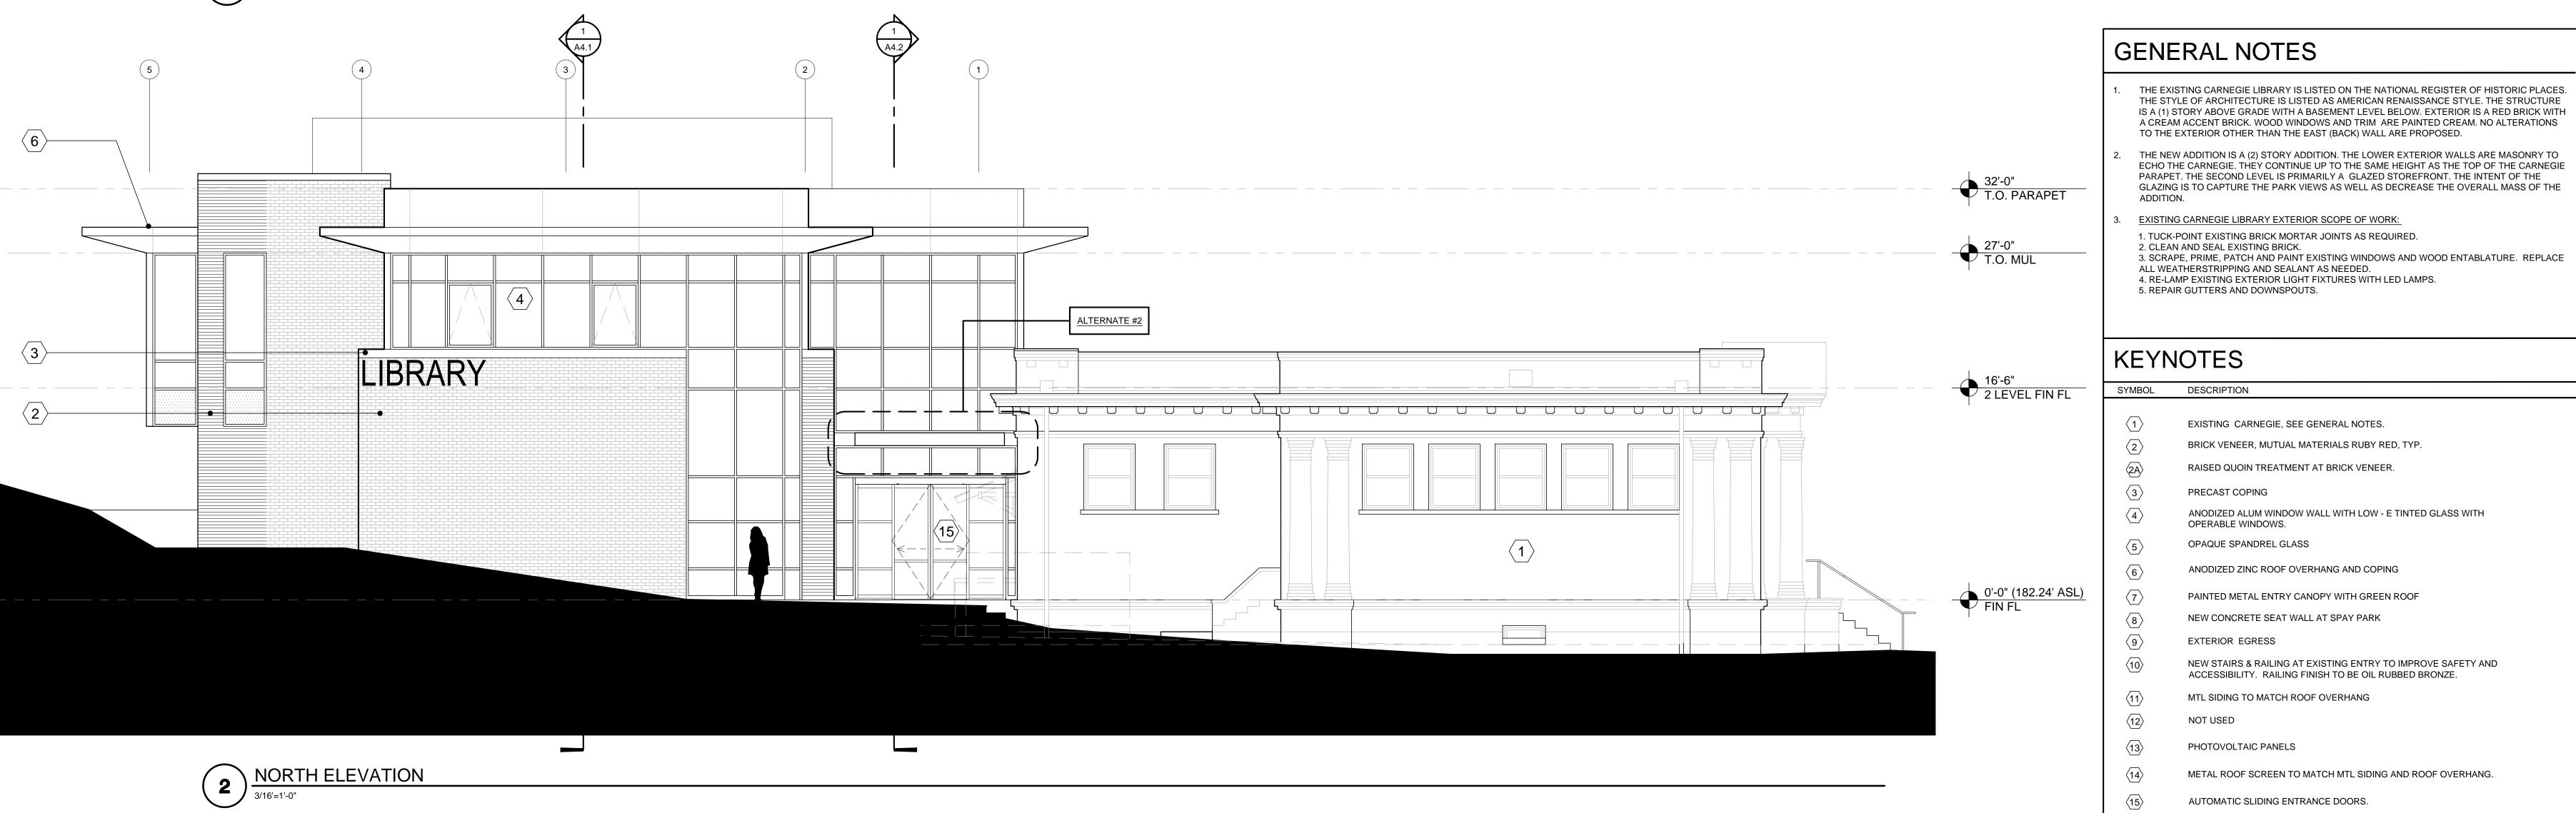


AUTOMATIC SLIDING ENTRANCE DOORS.

SITE PLAN DESIGN REVIEW & HISTORIC DESIGN REVIEW SUBMITTAL PACKAGE

EXTERIOR ELEVATIONS


Checked By: Sheet No:

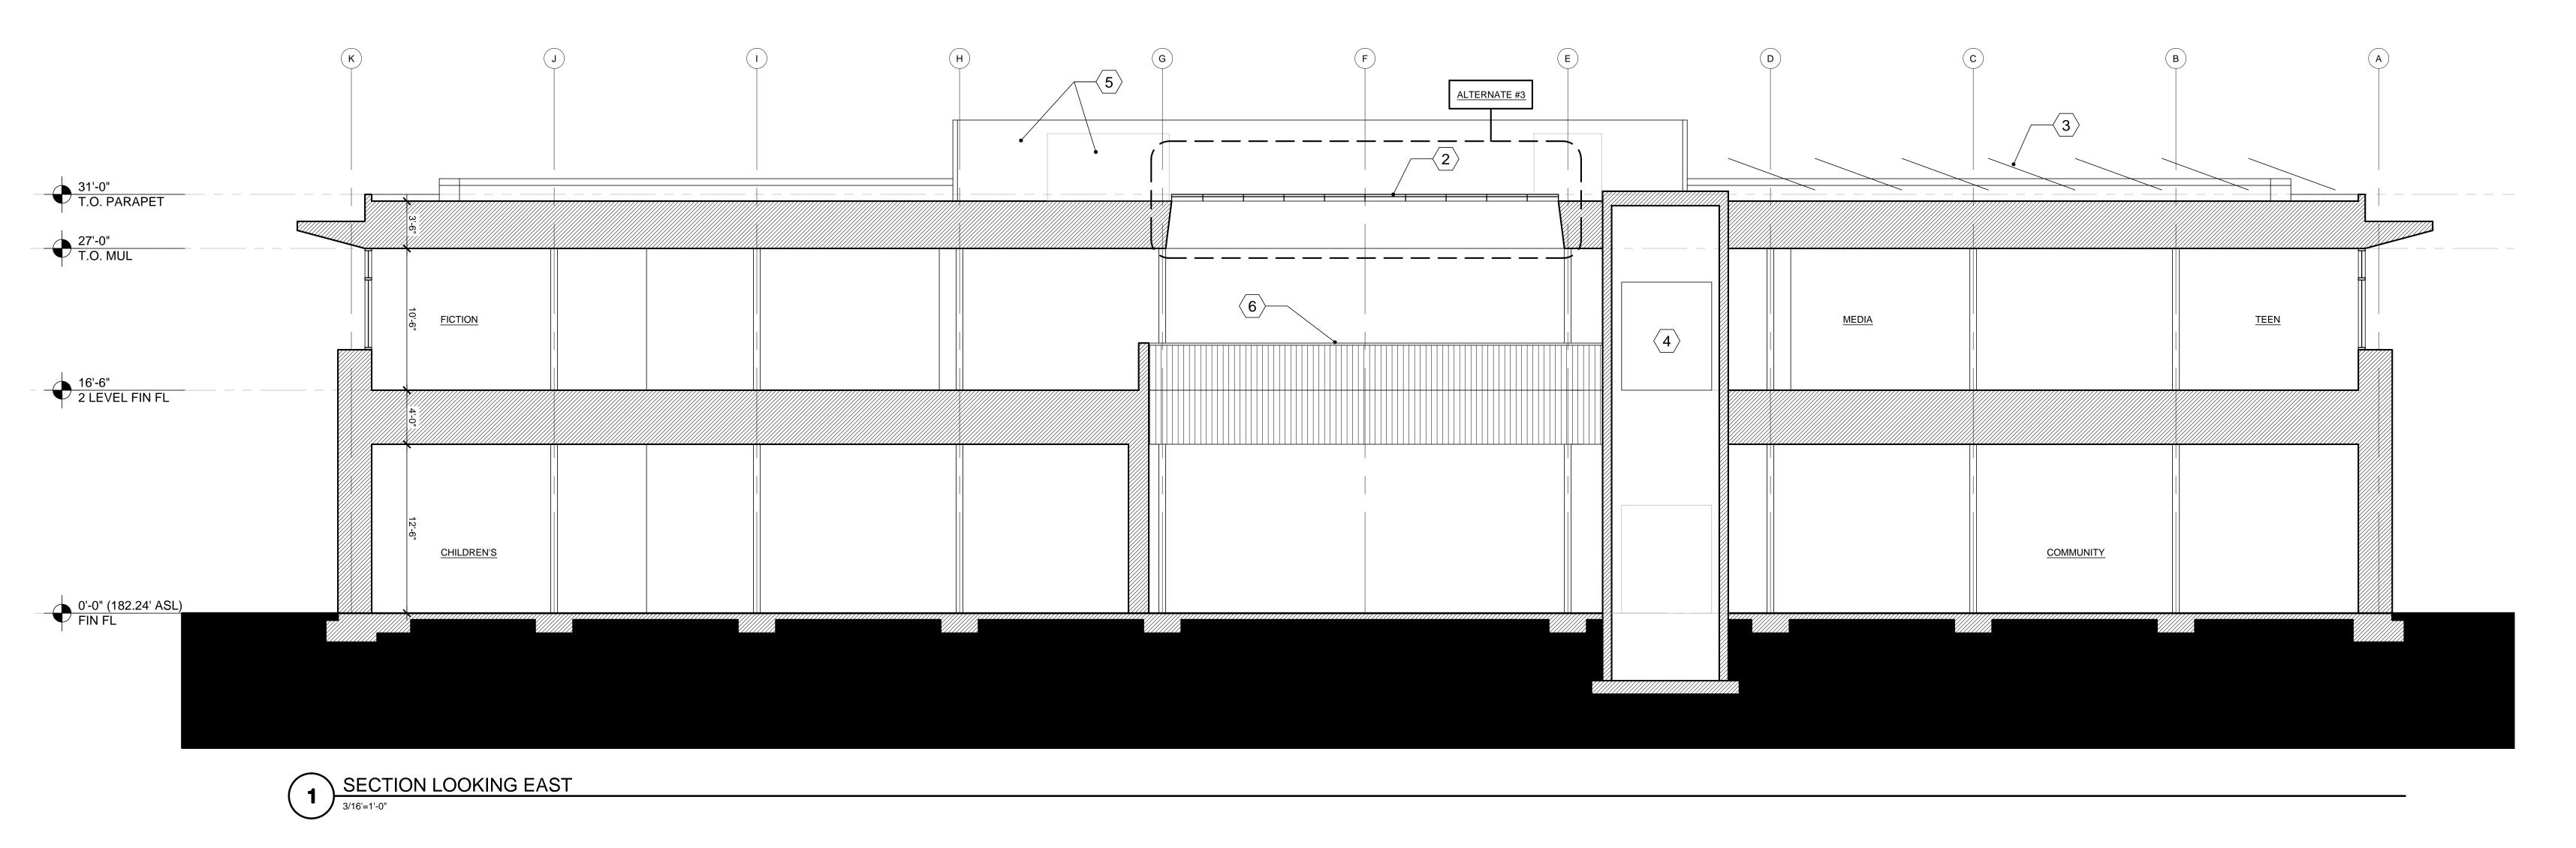

2525 E. Burnside St., Portland, OR 97214 phone:(503) 226-3617 www.seallp.com

OREGON CITY PUBLIC LIBRARY **RENOVATION & ADDITION**

OREGON CITY, OREGON

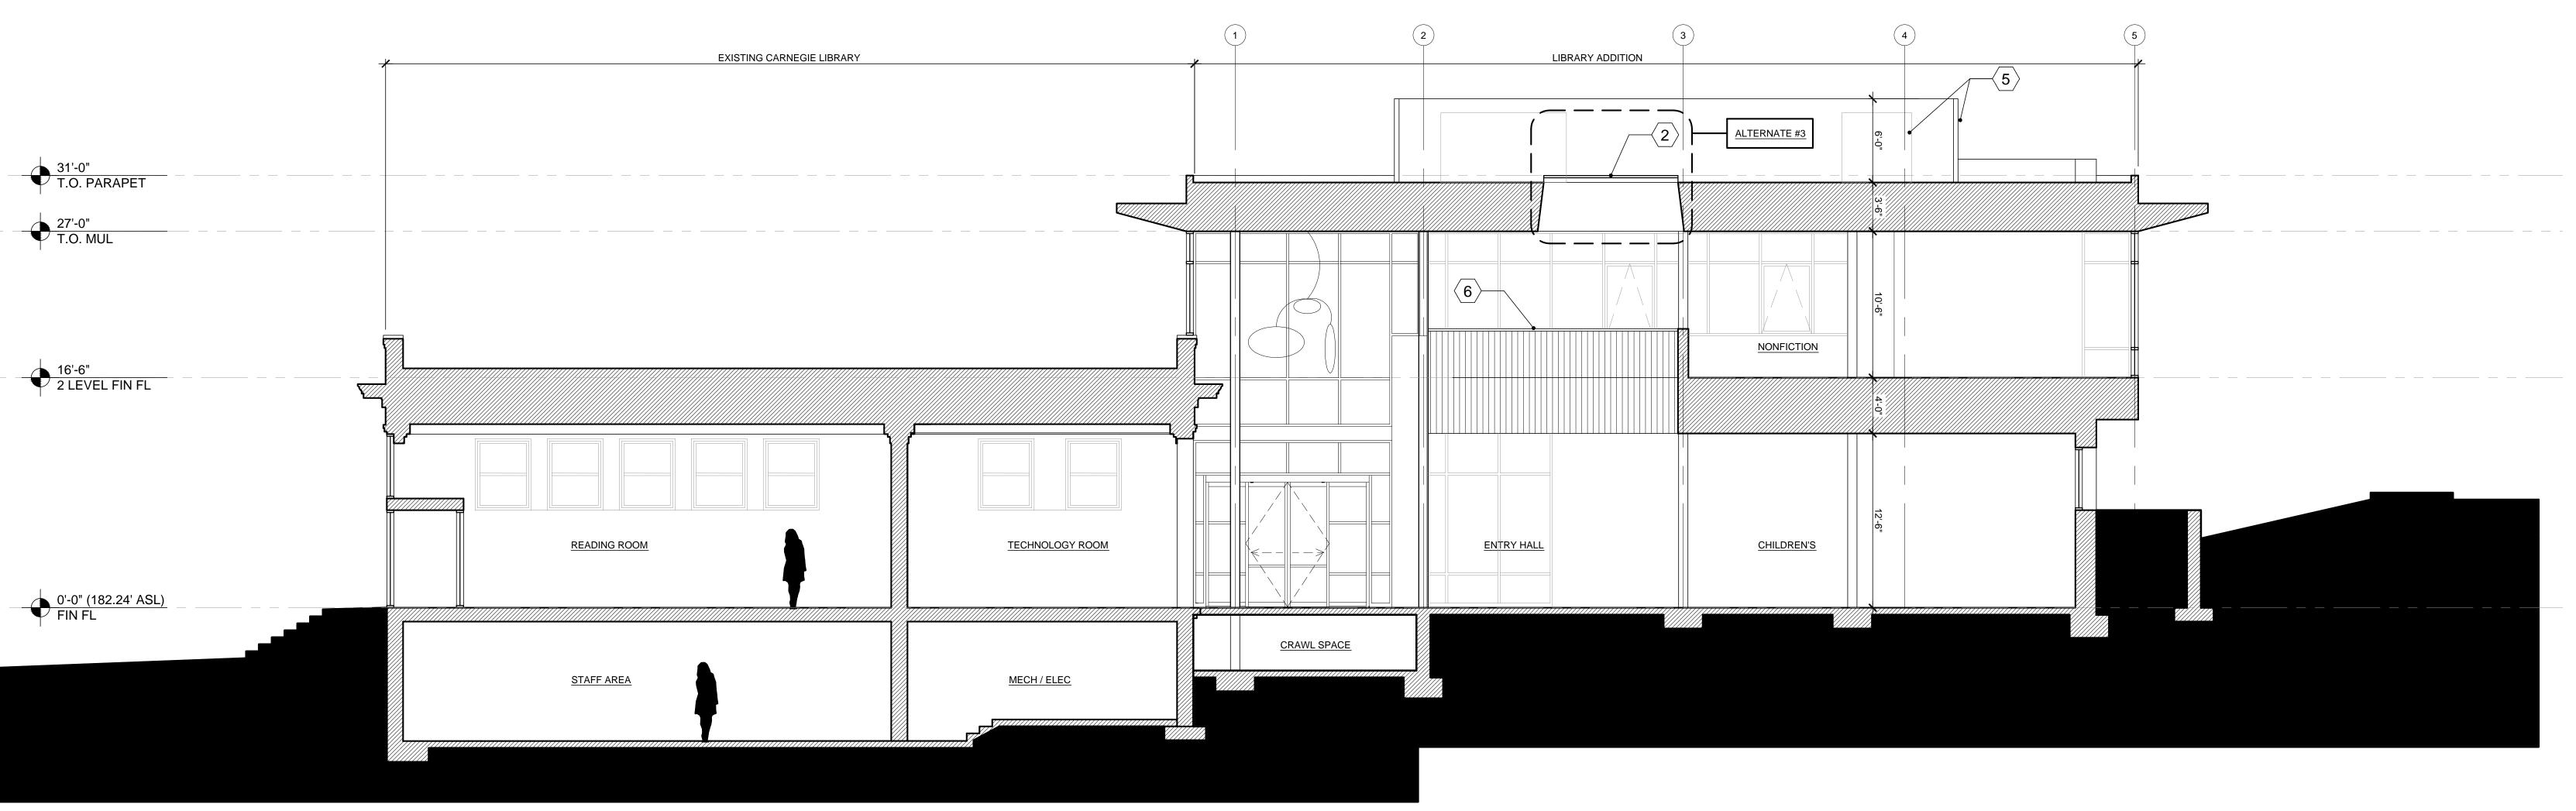

SECTION LOOKING NORTH

3/16'=1'-0"

SITE PLAN DESIGN REVIEW & HISTORIC DESIGN REVIEW

SUBMITTAL PACKAGE

DESCRIPTION	
EXTENSIVE MODULAR GREEN ROOF SYSTEM ON METAL ENTRY CANOPY	Drawing:
ATRIUM SKYLIGHTS	BUILDING SECTIONS

SCALE 3/16" = 1'-0"

KEYNOTES

SYMBOL DESCRIPTION

ELEVATOR CORE

PHOTOVOLTAIC PANELS

MECHANICAL UNITS AND METAL ROOF SCREEN.

POWDER COATED METAL GUARD RAIL WITH STAINED WOOD RAIL.

BRICK INFILL TO MATCH EXISTING WALL WHERE WINDOW REMOVED.

EXISTING WINDOW TO REMAIN, TEMPERED STOPPED IN GLAZING IN OPENING

GENERAL NOTES

THE EXISTING CARNEGIE LIBRARY IS LISTED ON THE NATIONAL REGISTER OF HISTORIC PLACES. THE STYLE OF ARCHITECTURE IS LISTED AS AMERICAN RENAISSANCE STYLE. THE STRUCTURE IS A (1) STORY ABOVE GRADE WITH A BASEMENT LEVEL BELOW. EXTERIOR IS A RED BRICK WITH

A CREAM ACCENT BRICK. WOOD WINDOWS AND TRIM ARE PAINTED CREAM. NO ALTERATIONS

THE NEW ADDITION IS A (2) STORY ADDITION. THE LOWER EXTERIOR WALLS ARE MASONRY TO

ECHO THE CARNEGIE. THEY CONTINUE UP TO THE SAME HEIGHT AS THE TOP OF THE CARNEGIE PARAPET. THE SECOND LEVEL IS PRIMARILY A GLAZED STOREFRONT. THE INTENT OF THE

GLAZING IS TO CAPTURE THE PARK VIEWS AS WELL AS DECREASE THE OVERALL MASS OF THE

TO THE EXTERIOR OTHER THAN THE EAST (BACK) WALL ARE PROPOSED.

1415 Job No: JANUARY 23, 2015 Drawn By: Checked By: Sheet No:





OREGON CITY, OREGON



31'-0" T.O. PARAPET 16'-6" 2 LEVEL FIN FL ALTERNATE #2 ALTERNATE #2 NEW OPENING TO EXISTING CARNEGIE VESTIBULE VESTIBULE 0'-0" (182.24' ASL) FIN FL CRAWL SPACE SECTION LOOKING WEST

SCALE 3/16" = 1'-0"


SITE PLAN DESIGN REVIEW & HISTORIC DESIGN REVIEW SUBMITTAL PACKAGE

GENERAL NOTES	KEYI	NOTES		
4 THE EVICTING CARNEGIE LIRRARY IS LIGHER ON THE NATIONAL REGISTER OF HISTORIC DI ACES	SYMBOL	DESCRIPTION		
1. THE EXISTING CARNEGIE LIBRARY IS LISTED ON THE NATIONAL REGISTER OF HISTORIC PLACES. THE STYLE OF ARCHITECTURE IS LISTED AS AMERICAN RENAISSANCE STYLE. THE STRUCTURE IS A (1) STORY ABOVE GRADE WITH A BASEMENT LEVEL BELOW. EXTERIOR IS A RED BRICK WITH A CREAM ACCENT BRICK. WOOD WINDOWS AND TRIM ARE PAINTED CREAM. NO ALTERATIONS	1	EXTENSIVE MODULAR GREEN ROOF SYSTEM ON METAL ENTRY CANOPY	Drawing:	
TO THE EXTERIOR OTHER THAN THE EAST (BACK) WALL ARE PROPOSED.	<u>2</u>	ATRIUM SKYLIGHTS	BUILDING	SECTIONS
2. THE NEW ADDITION IS A (2) STORY ADDITION. THE LOWER EXTERIOR WALLS ARE MASONRY TO ECHO THE CARNEGIE. THEY CONTINUE UP TO THE SAME HEIGHT AS THE TOP OF THE CARNEGIE	3	PHOTOVOLTAIC PANELS		
PARAPET. THE SECOND LEVEL IS PRIMARILY A GLAZED STOREFRONT. THE INTENT OF THE GLAZING IS TO CAPTURE THE PARK VIEWS AS WELL AS DECREASE THE OVERALL MASS OF THE	4	ELEVATOR CORE		
ADDITION.	(5)	MECHANICAL UNITS AND METAL ROOF SCREEN.		
	6	POWDER COATED METAL GUARD RAIL WITH STAINED WOOD RAIL.	Job No:	1415
	\(\frac{7}{7}\)\	BRICK INFILL TO MATCH EXISTING WALL WHERE WINDOW REMOVED.	Date:	JANUARY 23, 2015
	(8)	EXISTING WINDOW TO REMAIN, TEMPERED STOPPED IN GLAZING IN OPENING BELOW.	Drawn By:	
			Checked By:	-
			Sheet No:	
				A4.2

GENERAL ELECTRICAL NOTES

A. DESIGN OF STREET LIGHTING BY PGE PER PUBLIC WORKS. CONTACT: LORI SWANSON 503-742-8322



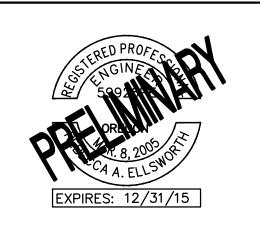

OREGON CITY
PUBLIC LIBRARY
RENOVATION &
ADDITION

OREGON CITY, OREGON



ACORN ARM MOUNTED
ON POLE STREET LUMINAIRE
(TYPICAL)

(E) ••••••

ELECTRICAL SYMBOL LIST

Abbreviations

(E) EXISTING

PP POWER POLE

(R) RELOCATE AND REUSE

<u>Lighting</u>

ACORN ARM MOUNTED ON POLE STREET LUMINAIRE

SURFACE OR PENDANT MOUNTED LUMINAIRE

Q WALL MOUNTED LUMINAIRE

ACORN POLE - TOP
 MOUNTED PEDESTRIAN LUMINAIRE

●☐ POLE MOUNTED FLOOD LIGHT

Powe

T UTILITY TRANSFORMER

Raceway

CONDUIT/WIRING CONTINUATION

CONDUIT/WIRING STUBBED OUT WITH END CAP OR INSULATED PLASTIC BUSHING

o POWER POLE

——P— UNDERGROUND PRIMARY SERVICE

——S— UNDERGROUND SECONDARY SERVICE

SITE PLAN DESIGN REVIEW &
HISTORIC DESIGN REVIEW
SUBMITTAL PACKAGE

Drawing: SITE L

SITE LIGHTING AND ELECTRICAL PLAN

Job No: 1415

Date: JANUARY 23, 2015

Drawn By: CK

Checked By: MO

Sheet No:

PROJECT 2014-0318
CONTACT Mark O'Leary

Checked

INTERFACE
ENGINEERING

TOR SW Third Avenue
Suite 400
Portland, OR 97204
TEL 503.382.2266
FAX 503.382.2262
www.interfaceengineering.com

ACORN POLE - TOP
MOUNTED PEDESTRIAN LUMINAIRE
(TYPICAL)

JOHN ADAMS ST

10 O

JEFFERSON ST


1 SITE LIGHTING AND ELECTRICAL PLAN

ACORN POLE - TOP
MOUNTED PEDESTRIAN LUMINAIRE
RESUED AND RELOCATED


POWER POLE (TYPICAL)

POLE MOUNTED — FLOOD LIGHT

					SHTING LI			ILDULL			
TYPE	DESCRIPTION	HOUSING	SHIELDING	MOUNTING	FINISH	UL/IP RATING	BALLAST	LAMP(S)	INPL WAT		NOTES
SA	EXTERIOR POST-TOP ACRON STYLE LUMINAIRE WITH LED LAMPING AND TYPE V DISTRIBUTION OPTICS.	NOMINAL 14-INCH DIAMETER BY 20-INCH TALL ACRYLIC GLOBE WITH 21C/8" GLOBE FITTER AND 22C GOLD FINIAL.	#197 ACRYLIC GLOBE WITH 22C GOLD FINIAL	12'-10" CAST IRON DECORATIVE ROUND POLE. POLE TO WITHSTAND 100 MILE PER HOUR WINDS WITH A GUST FACTOR OF 1.3.	TO MATCH EXISTING	WET	INTEGRAL	LED	TBD	VISCO VI-A18/CI/12'-10" - LED-V SERIES	LUMINAIRE AND POLE TO MAT EXISTING.
SB	EXTERIOR SURFACE MOUNTED LED DRUM	NOMINAL 10.25-INCH DIAMETER BY 4-INCH HIGH RUGGED CAST ALUMINUM TOP PLATE AND OUTER RING	WHITE ARCYLIC	SURFACE	DARK BRONZE	WET	INTEGRAL	NOMINAL 1029 LUMENS, 400	0K, 85 CRI. 18 WATTS	LITHONIA LIGHTING OLCFM SERIES OR APPROVED	
NOTES: 1 2 3	SPECIFIED MANUFACTURERS ARE	COMPLETE WITHOUT A COPY OF THE F APPROVED TO SUBMIT BID. INCLUSION IDE THE LUMINAIRE, LAMP AND BALLAST	DOES NOT RELIEVE MANUF	ACTURER FROM SUPPLYIN	G PRODUCT AS DESCRIE		I IGHTED. SUBMITTAI	LS NOT INCLUDING THIS IN		ETURNED AS REJECTED BY THE ENGINEER OF RECO	RD.

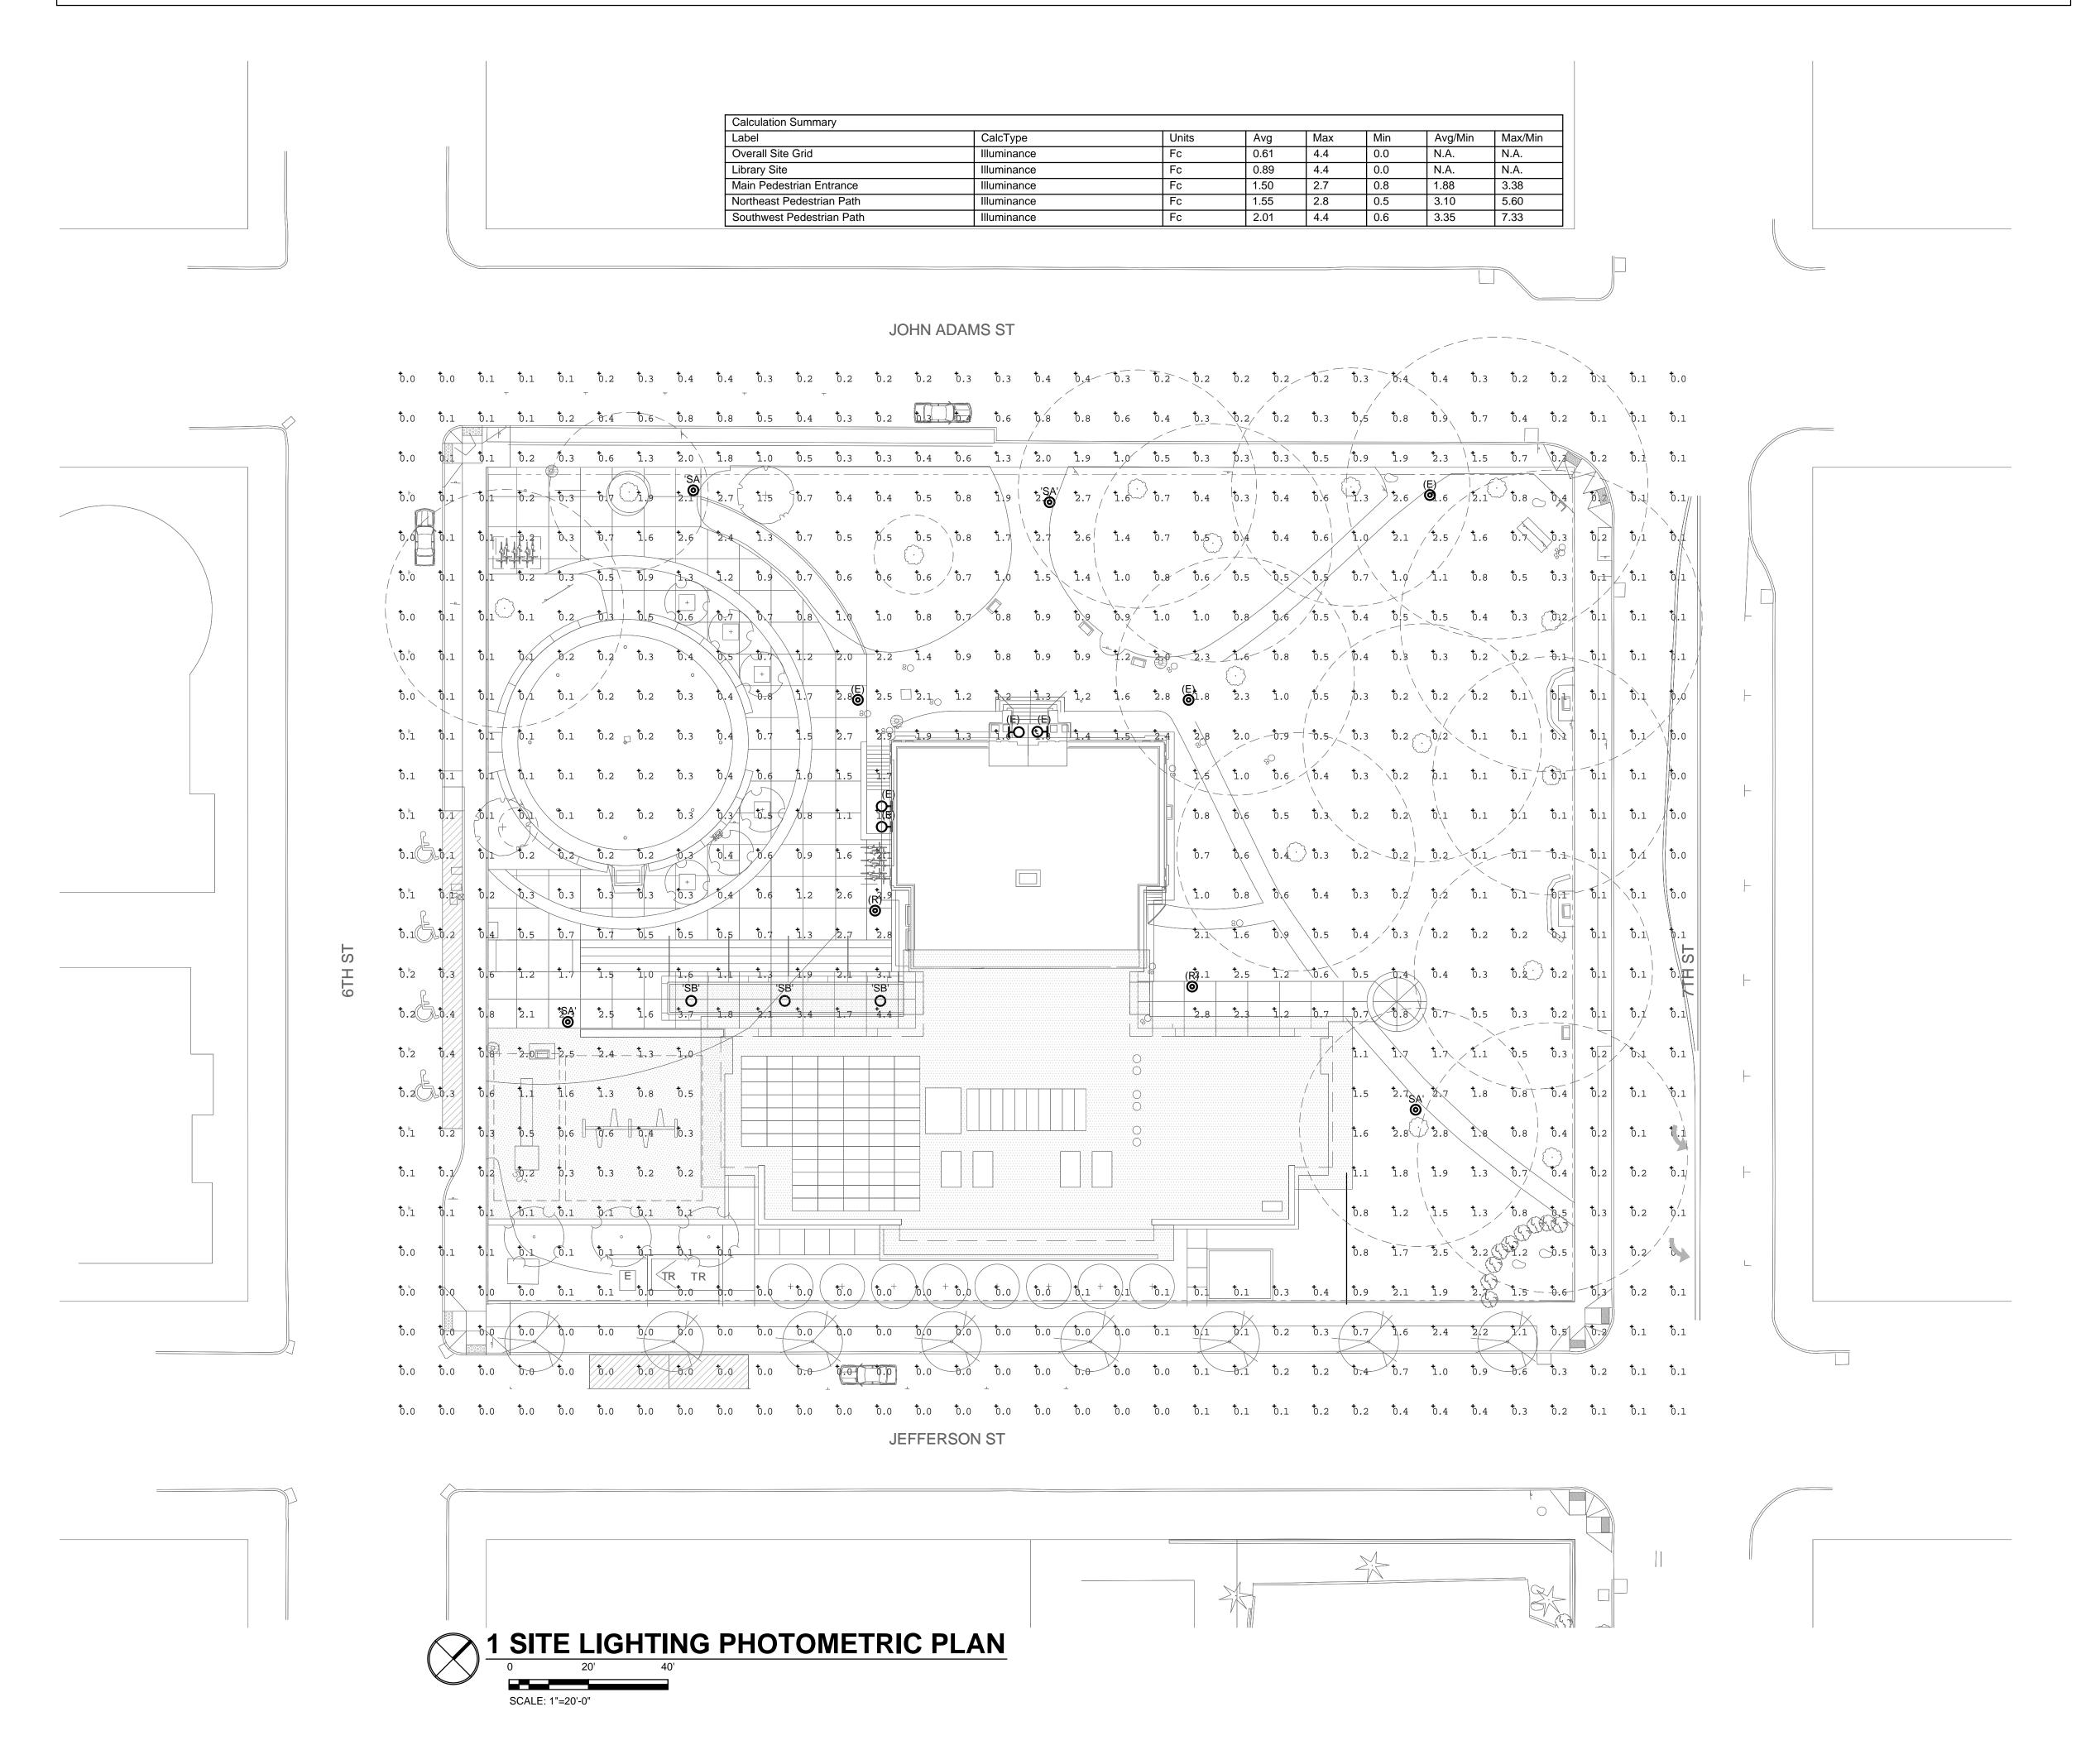



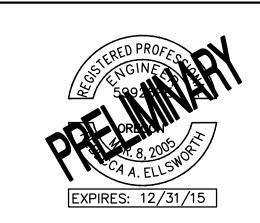

OREGON CITY
PUBLIC LIBRARY
RENOVATION &
ADDITION
OREGON CITY, OREGON

SITE PLAN DESIGN REVIEW &
HISTORIC DESIGN REVIEW
SUBMITTAL PACKAGE

Drawi

SITE LIGHTING PHOTOMETRIC PLAN

Job No: 1415

Date: JANUARY 23, 2015


Drawn By:

Checked By:

Sheet No:





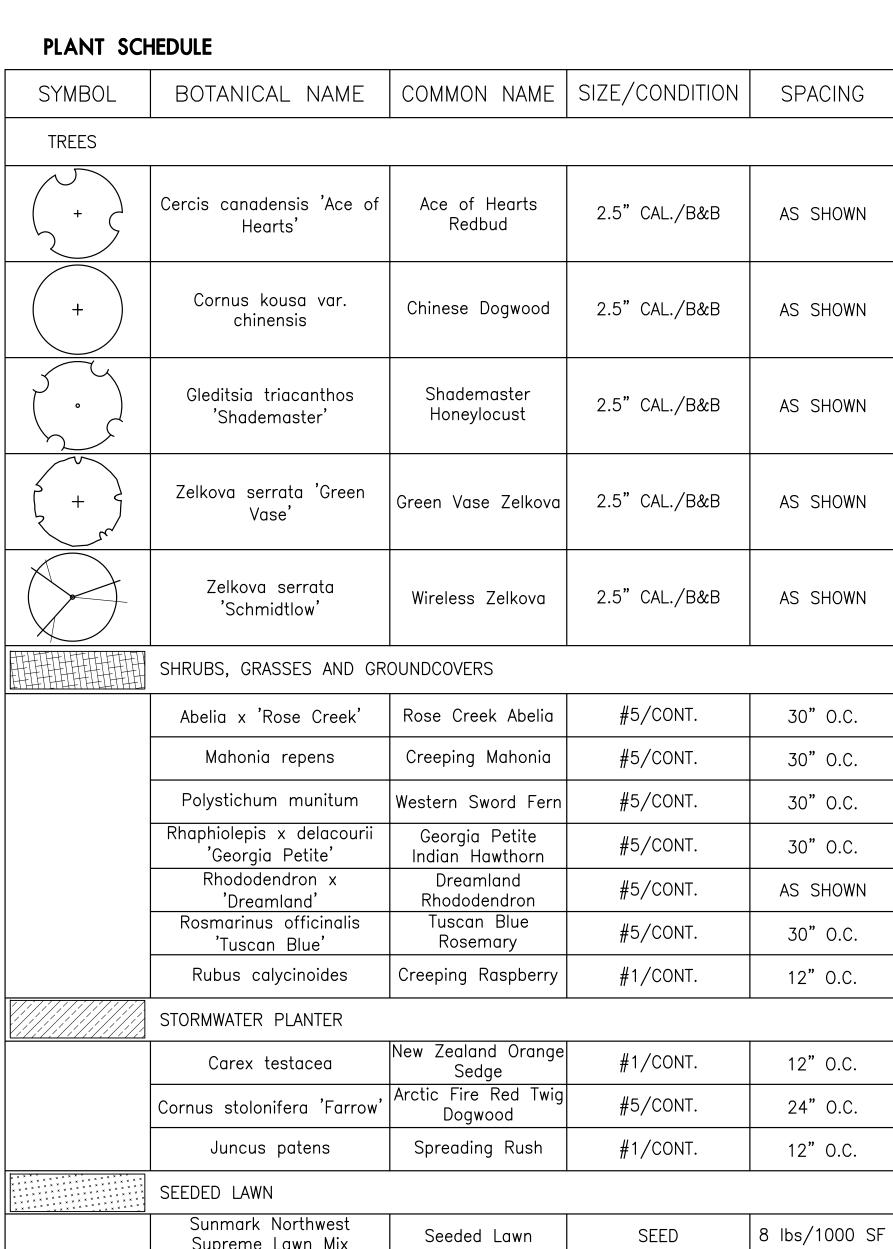

	Carex testacea	New Zealand Orange Sedge	#1/CONT.	12" O.C.	
	Cornus stolonifera 'Farrow'	Arctic Fire Red Twig Dogwood	#5/CONT.	24" O.C.	
	Juncus patens	Spreading Rush	#1/CONT.	12" O.C.	
**************************************	SEEDED LAWN				
	Sunmark Northwest Supreme Lawn Mix	Seeded Lawn	SEED	8 lbs/1000 SF	
	PROPERTY LINE/RIGHT-OF-		ARCHITECTURE BALLED & BURLAPPE		
LEGEND			A DDDEN	VIATIONS	
	PEDESTRIAN CONCRETE PAVI		CALIPER		
			CONT.	CONTAINER	
	PLAY AREA SAFETY SURFACI	NG	ELEC EX HT TYP	CONTAINER ELECTRICAL EXISTING HEIGHT TYPICAL	
	PLAY AREA SAFETY SURFACION EXISTING TREE TO BE PROT		ELEC EX HT TYP QTY W/	CONTAINER ELECTRICAL EXISTING HEIGHT	

OREGON CITY
PUBLIC LIBRARY
RENOVATION &
ADDITION

OREGON CITY, OREGON

lango.hansen

LANDSCAPE ARCHITECTS PC

1100 nw glisan #3B portland OR 97209 T 503 295.2437

SITE PLAN DESIGN REVIEW &
HISTORIC DESIGN REVIEW
SUBMITTAL PACKAGE

Drawing:

LANDSCAPE PLAN

Job No: 1415


Date: JANUARY 23, 2015

Drawn By: EK

Checked By: KL

Sheet No:

L1.00

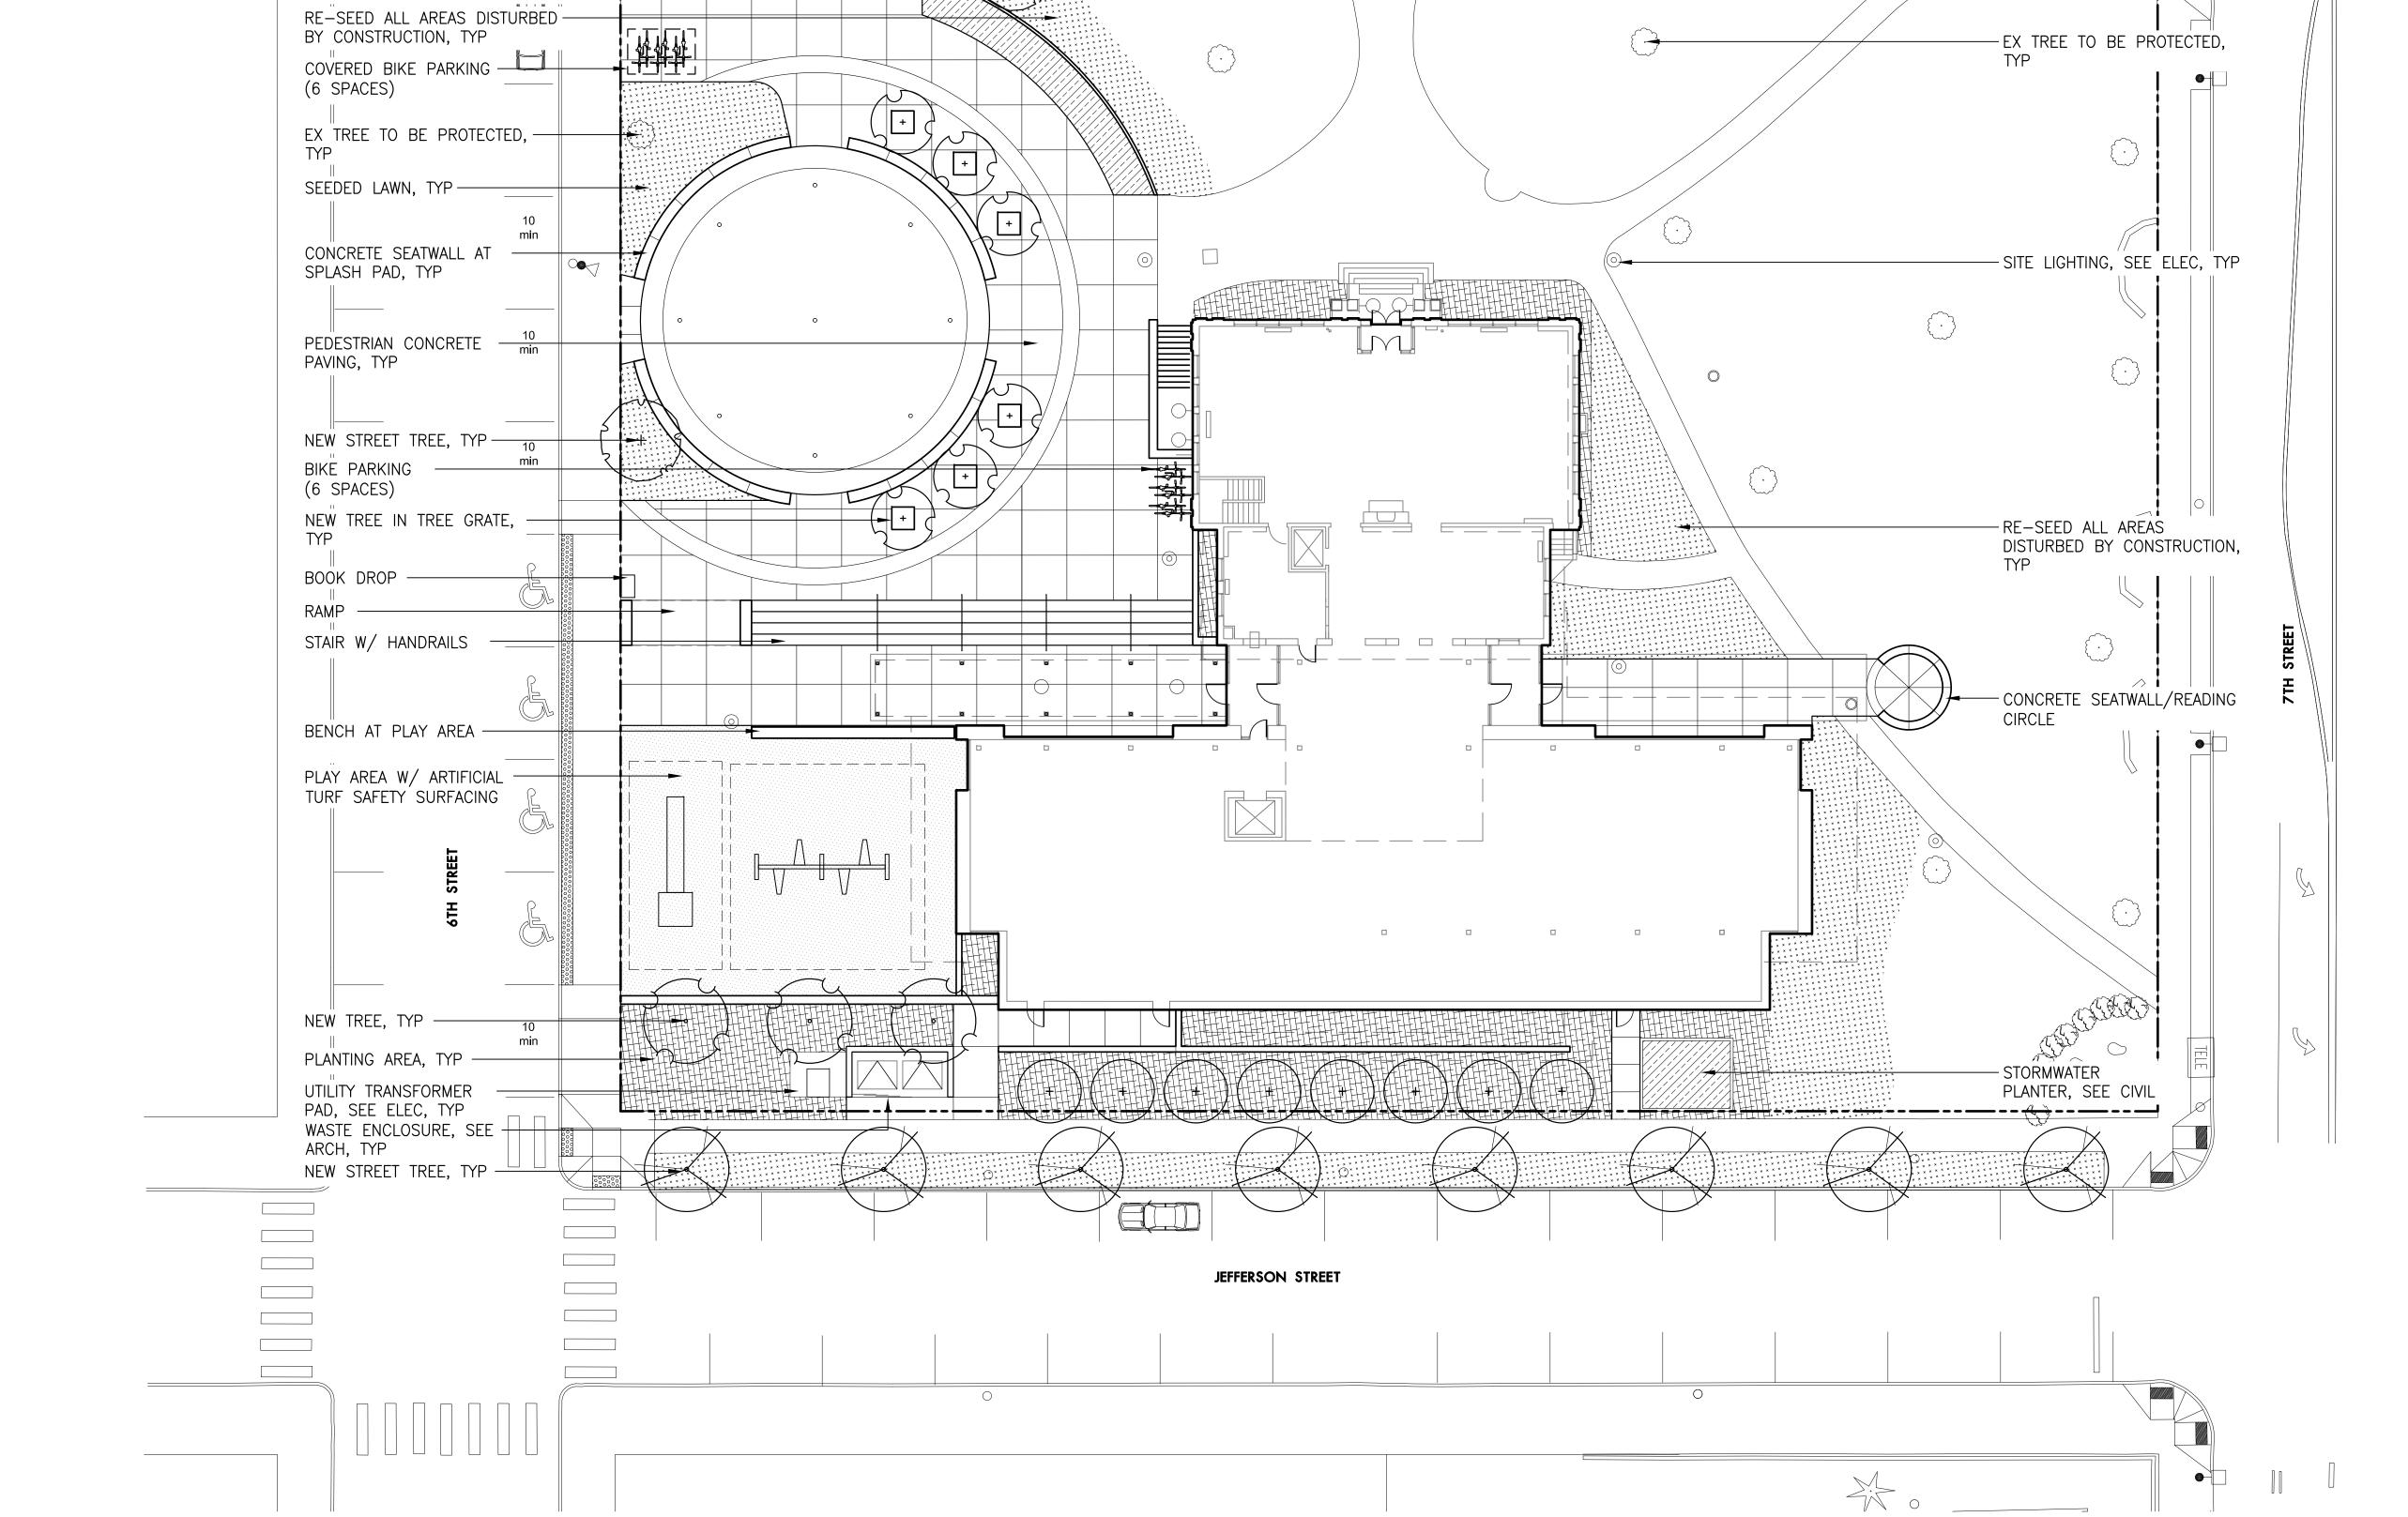

JOHN ADAMS STREET

NEW STREET TREE, TYP ----

1 LANDSCAPE PLAN

STORMWATER FACILITY, SEE CIVIL